

ADDENDUM TO BID DOCUMENTS

PALO VERDE COLLEGE PROJECT BID NO. 2018-01

PVC COLLEGE SERVICES BUILDING RENOVATIONS

1 COLLEGE DRIVE, BLYTHE, CA 92225

ADDENDUM #2

March 26, 2018

NOTE: ALL PLANS, SPECIFICATIONS AND CONTRACT DOCUMENTS REMAIN UNCHANGED EXCEPT SECTIONS OR PARTS ADDED TO, REVISED, DELETED OR CLARIFIED BY THIS ADDENDUM

This addendum (including all attachments) consists of (2) 8½"x11" pages and (14) 24"x36" plan sheets

CHANGES TO THE DRAWINGS

Note: All changes to the drawings have been clouded and identified with a Delta 1 revision

- Item 1: Reference Sheet G-002: Redundant GENERAL NOTES 33-52, have been removed.
Note 17 sentence overlap corrected
- Item 2: Reference Sheet G-004: Note added "SEE G-007 FOR NEW WORK REQUIRED"
- Item 3: Reference Sheet G-005: Revised to show all three areas of parking lot upgrades
- Item 4: Reference Sheet G-006: Keynote 1 revised to "FLUSH WITH PARKING SURFACE"
Keynote 2 removed
Keynote 4 revised to "RELOCATED ACCESSIBLE STALL SIGN"
- Item 5: Reference Sheet G-007: Keynote 3 revised to "NEW 42" GRAB BAR, EA. SIDE..."
Keynote 4, note added "PER SPECIFICATIONS"
Keynote 9 added
- Item 6: Reference Sheet G-008: Keynotes 5 and 6, note added "REPAIR/PATCH WALL TO
MATCH EXISTING AS NEEDED"
- Item 7: Reference Sheet A-200: Door "E6" revised to "E5"
Graphic changed and V.I.F. dimensions added to storefront demo
at south side of Room 210
- Item 8: Reference Sheet A-201: Keynote 4 removed. All flooring will be N.I.C.
Keynote 6 revised, note to "REUSE (E)" has been removed
Keynote 9 revised. All flooring will be N.I.C.
Keynote 12. New detail reference added for int condition, 5/A-800
Keynotes 15 and 16, detail references added
Added Keynotes 21 thru 25
Casework at Room 216 from contract, see Keynote 24
Doors "E1", "E2" & "E3" have been retagged to correct handing
- Item 9: Reference Sheet A-202: LEGEND revised
Keynote 6 revised

- Item 10: Reference Sheet A-700: DOOR SCHEDULE: Door #11, Elevation Type "D" added
Door Elevation Type "B" has been modified to show transom and side lite
Keynote 2 revised
- Item 11: Reference Sheet A-800 Detail 1, Note revised to "SOUND BATT WHERE OCCURS PER PLAN". See keynote 25 on sheet A-201
Detail 8, notes revised, flooring removed from scope
- Item 12: Reference Sheet A-801 Detail 2 added, CONCRETE JOINT DETAILS
- Item 13: Reference Sheet A-802 Details 5 & 7 have been removed
Note added to Detail 4, "NEW TACTILE ROOM ID TO MATCH EXISTING TACTILE ROOM ID, V.I.F."

CHANGES TO THE SPECIFICATIONS

No changes to the specifications

RESPONSES TO BIDDER QUESTIONS

Item 14:

Q1. Would you please let us know who your fire alarm contractor (A1) is and who the plumber was that worked on the Classroom Renovations Project last summer (A2)?

A1. We currently use Apple Valley Communication as our Fire Alarm Monitoring Service. However, we are currently using Mircom for repairs as we have found them to be less expensive in some instances. Both contractors are registered with the DIR. Below is their vendor information:

Apple Valley Communications Inc.
PO Box 787
21845 Highway 18
Apple Valley, CA 92307
Phone: 760-247-2668

Mircom
73 Bunsen
Irvine, CA 92618
Phone: 714-442-2064

A2. The contract who performed the plumbing work on the Classroom Renovations Project last summer was C.B. Plumbing. The work was completed on a time and materials basis. The contractor is registered with the DIR. The contractor's information is below:


C.B. Plumbing
345 North Main Street
Blythe, CA 92225
Phone: 760-922-6550

END OF ADDENDUM #2

- ALL CONTRACTORS SHALL BE EXPERIENCED AND THOROUGHLY KNOWLEDGEABLE IN THEIR RESPECTIVE AREAS OF THE CONSTRUCTION INDUSTRY AND SHALL PERFORM IN A RESPONSIBLE MANNER IN ESTABLISHED CONSTRUCTION SEQUENCE. IN REVIEWING THE DRAWINGS AND DETAILS, THE CONTRACTOR SHALL INFORM THE ARCHITECT OF POTENTIAL PROBLEMS WHEN DRAWINGS ARE UNCLEAR OR INCONSISTENT.
- ALL REFERENCES MADE IN THE PLANS, SPECIFICATIONS AND CONTRACT DOCUMENTS TO THE CONTRACTOR SHALL ALSO APPLY TO THE SUBCONTRACTOR. THE CONTRACTOR SHALL ALSO BE RESPONSIBLE TO NOTIFY THE ARCHITECT OF DISCREPANCIES OR CONFLICTS IN THE DRAWINGS FOUND DURING BIDDING AND/OR CONSTRUCTION PRIOR TO PERFORMING THE WORK. THE ARCHITECT SHALL RESOLVE SUCH DISCREPANCIES EXPEDITIOUSLY AND NOTIFY THE CONTRACTOR EITHER VERBALLY OR IN WRITING AS APPLICABLE TO THE CONDITION. IF CONFLICTS ARE NOT BROUGHT TO THE ATTENTION OF THE ARCHITECT DURING THE BID PROCESS IT IS ASSUMED THAT THE CONTRACTOR WILL BE RESOLVING THE CONFLICT IN THE MOST INEXPENSIVE WAY.
- UTILITIES ARE DIAGRAMMATICALLY LOCATED ON THE DRAWING SOLELY FOR THE CONVENIENCE OF THE CONTRACTOR. THE CONTRACTOR IS EXPRESSLY WARNED THAT SUCH INDICATIONS ARE ONLY APPROXIMATE AS TO ACTUAL LOCATION. IT IS THE CONTRACTOR'S RESPONSIBILITY TO RELOCATE ANY AND ALL UTILITIES REQUIRED TO COMPLETE THE SCOPE OF WORK.
- ALL WORKMANSHIP AND MATERIALS SHALL CONFORM TO THE REQUIREMENTS OF THE LATEST EDITION OF THE C.B.C. AND TITLE 24 AS ADOPTED AND AMENDED BY LOCAL GOVERNING AGENCIES.
- WHERE NO CONSTRUCTION DETAILS OR NOTES ARE SHOWN FOR ANY PART OF THE WORK, IT IS THE SOLE RESPONSIBILITY OF THE CONTRACTOR TO PERFORM THE WORK TO CONFORM TO SIMILAR STANDARD DETAILS AS REGULATED BY LOCAL GOVERNING AGENCIES.
- IF NOT SPECIFICALLY DEFINED IN THESE DRAWINGS, MATERIALS AND/OR EQUIPMENT SHALL BE IDENTIFIED BY THE CONTRACTOR TO THE ARCHITECT WITHIN A REASONABLE AMOUNT OF TIME TO ALLOW SELECTION, PURCHASE AND DELIVERY SO AS TO PREVENT DELAY IN THE JOB SCHEDULE.
- MATERIAL SUBSTITUTION SHALL BE APPROVED BY THE ARCHITECT AND OWNER PRIOR TO THE PURCHASE AND INSTALLATION.
- ALL MATERIAL SHALL BE HANDLED AND INSTALLED PER MANUFACTURERS SPECIFICATIONS AND RECOMMENDATIONS.
- ALL COLORS AND / OR COLOR SAMPLES SHALL BE SUBMITTED TO THE ARCHITECT AND OWNER FOR REVIEW AND APPROVAL PRIOR TO INSTALLATION OR APPLICATION.
- TOILET ROOMS SHALL HAVE AN AIR CHANGE OF FOUR (4) COMPLETE VOLUMETRIC AIR CHANGES PER HOUR.
- NEITHER THE OWNER OR ARCHITECT ARE RESPONSIBLE FOR ENFORCING SAFETY MEASURES OR REGULATIONS. THE CONTRACTOR SHALL DESIGN, CONSTRUCT AND MAINTAIN ALL SAFETY DEVICES, INCLUDING SHORING AND BRACING AND BE SOLELY RESPONSIBLE FOR CONFORMING TO ALL LOCAL, STATE AND FEDERAL SAFETY AND HEALTH STANDARDS, LAWS AND REGULATIONS.
- ATTIC SEPARATIONS AS REQUIRED BY GOVERNING AGENCIES SHALL BE PROVIDED, WHETHER INDICATED ON THESE PLANS OR NOT.
- THE CONTRACTOR IS REQUIRED TO VISIT THE SITE AND BECOME AWARE OF ALL VISIBLE EXISTING CONDITIONS, ASCERTAIN THE LIMITS OF WORK, (AS RELATED TO EXISTING CONDITIONS AND IMPROVEMENTS) LIMITS OF SITE ACCESS FOR EQUIPMENT, MATERIAL DELIVERY AND STORAGE AND CONSTRUCTION FORCES.
- THE CONTRACTOR SHALL CHECK AND VERIFY ALL FIELD MEASUREMENTS AND SHALL SUBMIT FOR REVIEW, WITH SUCH PROMPTNESS AS TO CAUSE NO DELAY IN HIS OWN WORK OR THAT OF ANY SUBCONTRACTOR. ALL SHOP OR SETTING DRAWINGS AND SCHEDULES REQUIRED FOR THE WORK OF THE VARIOUS TRADES.
- SUBMITTAL DOCUMENTS FOR DEFERRED SUBMITTAL ITEMS SHALL BE SUBMITTED TO THE ARCHITECT OR ENGINEER OF RECORD, WHO SHALL REVIEW THEM AND FORWARD THEM TO THE BUILDING OFFICIAL WITH A NOTATION INDICATING THAT THEY HAVE BEEN REVIEWED AND THAT THEY HAVE BEEN FOUND TO BE IN GENERAL CONFORMANCE WITH THE DESIGN OF THE BUILDING. THE DEFERRED SUBMITTAL ITEMS SHALL NOT BE INSTALLED UNTIL THEIR DESIGN AND SUBMITTAL DOCUMENTS HAVE BEEN APPROVED BY THE BUILDING OFFICIAL. THE DEFERRED SUBMITTAL ITEMS ARE: NONE AT THIS TIME
- VERIFY WITH ARCHITECT WHETHER THESE NOTES OR SPECIFIC NOTES ON DRAWINGS SHALL TAKE PRECEDENCE IN CASE OF CONFLICT.
- WRITTEN DIMENSIONS ON THESE DRAWINGS SHALL GOVERN. DO NOT SCALE DRAWINGS UNLESS DIRECTED BY ARCHITECT.
- VERIFY EXACT LOCATION OF HOLES IN FLOOR, WALLS, AND ROOF FOR PLUMBING, HVAC, AND ELECTRICAL WITH RESPECTIVE CONTRACTORS AND SUB CONTRACTORS.
- OWNER OR HIS AUTHORIZED AGENT SHALL BE RESPONSIBLE FOR ALL SCHEDULING AND COORDINATION. ALL DRAWINGS HAVE BEEN DRAWN TO SCALES AS INDICATED UNLESS OTHERWISE SHOWN; HOWEVER, MECHANICAL, FIRE PROTECTION AND ELECTRICAL SYSTEMS MAY BE OF SCHEMATIC LAYOUT. CONTRACTOR SHALL BE RESPONSIBLE FOR SCHEDULING AND COORDINATION OF ALL ROUGH-IN AND FINISH INSTALLATIONS OF AND VERIFICATION OF NON-INTERFERENCE BETWEEN ALL SYSTEMS.
- WALLS: SEE DRAWINGS FOR LEGEND, STUD SIZES AND SPACING. FRAMING MEMBERS INDICATED ARE SCHEMATIC, ADDITIONAL MEMBERS MAY BE REQUIRED TO PROPERLY MAINTAIN RIGIDITY, BACKING, ELECTRICAL BRACING, ETC. FOR A COMPLETE INSTALLATION. ALL INSTALLATIONS SHALL CONFORM TO THE MANUFACTURER'S ICBO APPROVED SYSTEM.
- IF SMOKE AND FIRE DAMPERS ARE REQUIRED, CONTRACTOR SHALL SUPPLY AND INSTALL AS REQUIRED BY LOCAL CODE.
- DRILLED-IN OR SHOT-IN CONCRETE ANCHORS USED FOR HANGER WIRES MUST BE FIELD TESTED. ONE OUT OF TEN MUST BE TESTED FOR 200 POUNDS OF TENSION. DRILLED IN CONCRETE ANCHORS USED FOR BRACING WIRES MUST BE FIELD TESTED. ONE OUT OF TWO MUST BE TESTED FOR 440 POUNDS OF TENSION. IF ANY TEST FAILS, ALL ADJACENT WIRES MUST BE TESTED.
- ICBO REPORT NUMBERS WHERE SHOWN ON DRAWINGS AND IN THE SPECIFICATIONS ARE SHOWN ONLY TO INDICATE THE REQUIREMENTS BY THE LOCAL BUILDING DEPARTMENT. OTHER PRODUCTS WITH APPROVED ICBO REPORT NUMBER MAY BE USED IF SUBMITTED TO THE ARCHITECT PRIOR TO INSTALLATION.
- ALL FURRED CEILINGS SHALL COMPLY WITH C.B.C.
- PLUMBING AND ELECTRICAL PENETRATIONS THROUGH WALLS FOR SEPARATION OF OCCUPANCY AND AREA, CORRIDOR, OR OTHER FIRE SEPARATIONS SHALL COMPLY WITH SEC. 713-C.B.C.
- ADDITIONALLY, STEEL OUTLET BOXES AT OCCUPANCY SEPARATION WALLS SHALL NOT EXCEED SIXTEEN SQUARE INCHES, SHALL NOT EXCEED ONE HUNDRED SQUARE INCHES PER ONE HUNDRED SQUARE FEET OF WALL, AND SHALL BE SEPARATED BY A HORIZONTAL DISTANCE OF TWENTY-FOUR INCHES WHEN ON OPPOSITE SIDES OF A WALL PER 713 C.B.C. DUCTS PENETRATING OCCUPANCY SEPARATIONS MUST HAVE SMOKE AND FIRE DAMPERS PER 713 C.B.C.
- BRACING AND TEMPORARY SUPPORT SHALL BE PROVIDED AS REQUIRED TO HOLD THE WORK SECURELY IN PLACE AND TO SUSTAIN ALL LOADS THAT MAY DURING ERECTION AND UNTIL SUBSEQUENT CONSTRUCTION IS ADEQUATE TO REPLACE TEMPORARY BRACING.
- ALL FIXED GLASS PANELS ADJACENT TO DOORS AND GLAZING ADJACENT TO WALKING SURFACE MUST BE OF SAFETY GLAZING MATERIAL.
- ALL SHOT PINS SHALL BE HILTI DS (0.177" DIA) LOW VELOCITY FASTENER (IC-ESR-1663), 32" O.C.
- WHEN SPECIAL INSPECTION IS REQUIRED, THE ARCHITECT OR ENGINEER OF RECORD SHALL SUBMIT THE NAME AND INFORMATION OF THE SPECIAL INSPECTION TEAM TO THE CITY FOR REVIEW AND APPROVAL.

GENERAL NOTES

- MATERIAL SUBSTITUTION SHALL BE APPROVED BY THE ARCHITECT AND OWNER PRIOR TO THE PURCHASE AND INSTALLATION.
- ALL MATERIAL SHALL BE HANDLED AND INSTALLED PER MANUFACTURERS SPECIFICATIONS AND RECOMMENDATIONS.
- ALL COLORS AND / OR COLOR SAMPLES SHALL BE SUBMITTED TO THE ARCHITECT AND OWNER FOR REVIEW AND APPROVAL PRIOR TO INSTALLATION OR APPLICATION.

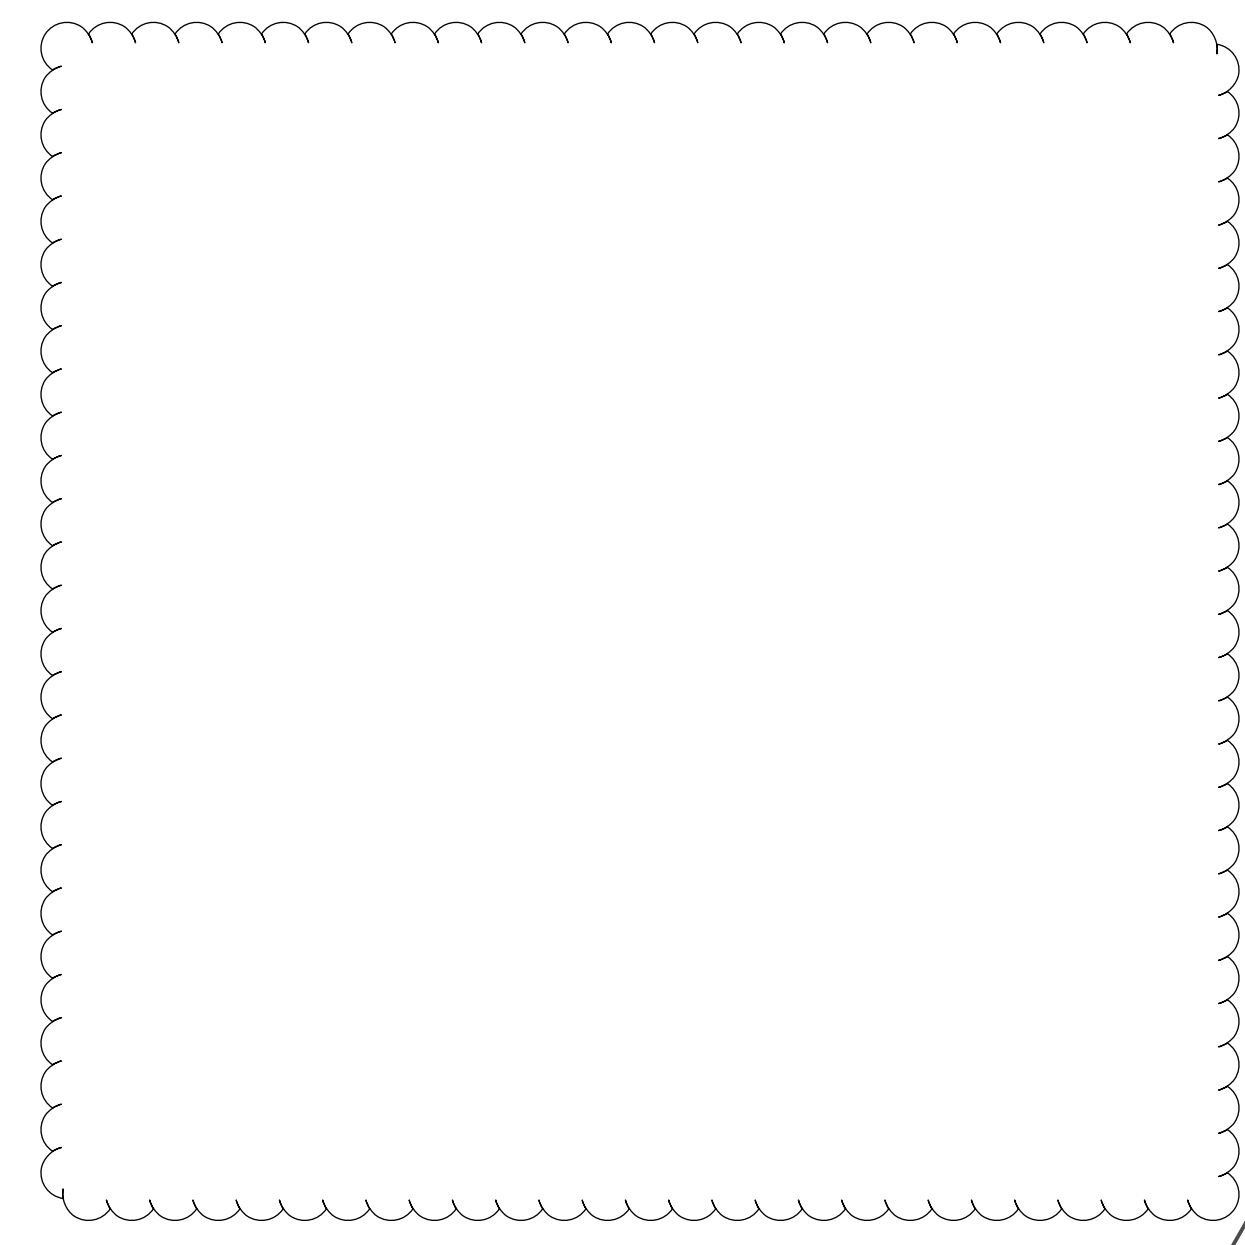

& L	AND ANGLE	E	EAST EACH	KJ	KEYED COLD JOINT	S	SOUTH
@	AT EACH	EF	EACH FACE	KO	KITCHEN	SC	SQUARE FEET
C.L.	CENTERLINE	EJ	EXPANSION JOINT	KP	KNOCKOUT	SC	SCHEDULE
#	DIAMETER	ELEV	ELEVATION	KPL	KICK PLATE	SD	SOAP DISPENSER
(E)	POUND OR NUMBER EXISTING	ELEC	ELECTRICAL	LAB	LABORATORY	SEC	SECTION
A.A.	ALL AROUND	EMER	EMERGENCY	LAM	LAMINATE	SLV	SHELF/SHELVING
ACOUS	ACCOUSTICAL	ENCL	ENCLOSURE	LAV	LAVATORY	SHR	SHOWER
AD	AREA DRAIN	EP	ELECTRICAL PANEL	LKR	LOCKER	SHT	SHEET
ADJ	ADJUSTABLE	EQ	EQUAL	LT	LIGHT	SIM	SIMILAR
AGGR	AGGREGATE	EQUIP	EQUIPMENT	LAD	LADDER	SLD	SLIDING
AL	ALUMINUM	EST	ESTIMATE	LAG	LAG BOLT	SD	STORM DRAIN
APPROX	APPROXIMATE	EXP	EXPOSED	LH	LEFT HAND	SPEC	SPECIFICATION
ARCH	ARCHITECTURAL	EXP	EXPANSION	L	LENGTH/LONG	SQ	SQUARE
ASPH	ASPHALT	EXT	EXTERIOR	LW	LIGHT WEIGHT	SS	STAINLESS STEEL
AC	ASPHALT CONCRETE	EPDM	ETHYLENE PROPYLENE	LL	LIVE LOAD	SKS	SERVICE SINK
ACC	ACCESS COMPO	EXH	EXHAUST	LL	LOUVER	STF	STORE FRONT
AP	ACCESS PANEL	EL	ELEVATOR	LIN	LINTEL	STA	STATION
ACP	ASPHALT CONCRETE PAVING	EIF	EXTERIOR INSULATING FINISH SYSTEM	MAX	MAXIMUM	STD	STANDARD
ADD	ADDENDUM	FA	FIRE ALARM	MC	MEDICINE CABINET	STL	STEEL
ADH	ADHESIVE	FAS	FASTENER	MECH	MECHANICAL	STO	STORAGE
ADJ	ADJACENT	FD	FLOOR DRAIN	MEMB	MEMBRANE	STR	STRUCTURAL
AFF	ABOVU FINISH FLOOR	FDN	FOUNDATION	MTL	METAL	SUSP	SUSPENDED
A/C	AIR CONDITIONING	FES	FIRE EXTINGUISHER	MFR	MANUFACTURER	SYM	SYMMETRICAL
ALT	ALTERNATE	FFC	FIRE EXTINGUISHER	MH	MANHOLE	SA	SUPPLY AIR
AB	ANCHOR BOLT	FHC	CABINET	MIN	MINIMUM	SD	SMOKE DETECTOR
ANOD	ANODIZED	FIN	FIRE HOSE CABINET	MIR	MIRROR	SKL	SKYLIGHT
AT	ASHALT TILE	FL	FINISH	MISC	MISCELLANEOUS	SPK	SPEAKER
AUTO	AUTOMATIC	FLASH	FLOOR	MO	MASONRY OPENING	SYS	SYSTEM
AV	AUDIO VISUAL	FLOU	FLASHING	MTD	MOUNTED	SHTG	SHEATHING
BD	BOARD	FLOU	FLOOR	MUL	MULLION	T	TREAD
BITMUN	BITUMIOUS	FOF	FACE OF CONCRETE	MB	MACHINE BOLT	TB	TOWEL BAR
BLDG	BUILDING	FOS	FACE OF FINISH	MAS	MASONRY	TC	TOP OF CURB
BLK	BLOCK	FOM	FACE OF STUD	MED	MEDIUM	TEL	TELEPHONE
BLKG	BLOCKING	FRP	FACE OF MASONRY	MDO	MEDIUM DENSITY OVERLAY	TZ	TERAZZO
BM	BEAM	FT	FIBER REINFORCED PANEL	MOD	MODIFIED	T&G	TONGUE AND GROOVE
BTM	BOTTOM	FTG	FOOT/FEET	MOV	MOVABLE	THK	THICK
BMK	BENCHMARK	FURR	FOOTING	MLD	MOLDING	TP	TOP OF PAVEMENT
BET	BETWEEN	FUT	FUTURING	MAT	MATERIAL	TPH	TOILET PAPER HOLDER
BRZ	BRONZE	FUT	FUTURING	MRB	MARBLE	TV	TELEVISION
CAB	CABINET	FFE	FUTURE	MRD	METAL ROOF DECK	TW	TOP OF WALL
CB	CATCH BASIN	FF	FINISH FLOOR	N	NORTH	TYP	TYPICAL
CEM	CEMENT	FG	FINISH GRADE	NIC	NOT IN CONTRACT	THRES	THRESHOLD
CER	CERAMIC	FP	FIRE PROOF	NOM	NOMINAL	TR	TRANSOM
CI	CAST IRON	FHMS	FLAT HEAD MACHINE SCREW	NTS	NOT TO SCALE	TOS	TOP OF SLAB
CIP	CAST IN PLACE	FHWS	FLAT HEAD WOOD SCREW	OA	OVERALL	TG	TEMPERED GLASS
CIR	CIRCLE	FL	FLOOR LINE	OBS	OBSCURE	TS	TOP OF STEEL
CLG	CEILING	FS	FLOOR DRAIN	OC	ON CENTER	TK&D	TACK BOARD
CLJK	CALLING	FIX	FLOOR SINK	OD	OUTSIDE DIAMETER	UNF	UNFINISHED
CLO	CLOSET	FPL	FIXTURE	OFF	OFFICE	UNO	UNLESS NOTED OTHERWISE
CLR	CLEAR	FBO	FIREPLACE	OPF	OPENING	UR	URNAL
CO	CLEAN OUT	GA	GALVANIZED	OPP	OPPOSITE	UL	UNDERWRITER'S LABORATORY
COL	COLUMN	GALV	GALVE	OCC	OCCUPANT	VERT	VERTICAL
CONC	CONCRETE	GB	GENERAL	OPH	OPPOSITE HAND	VEST	VESTIBULE
CONN	CONNECTION	GL	GLASS	OHMS	OVAL HEAD MACHINE SCREW	VB	VAPOR BARRIER
CONST	CONSTRUCTION	GL	GLASS, GLAZING	OHWS	OVAL HEAD WOOD SCREW	VCT	VINYL COMPOSITION TILE
CONTIN	CONTINUOUS	GND	GENERAL CONTRACTOR	OH	OVERHEAD	VB	VINYLE BASE
CORR	CORRIDOR	GYP	GYPSUM BOARD	OV/	OVER	W	WEST
CSK	COUNTERSINK	GI	GYPSUM BOARD	PAN	PANEL	W/	WITH
CTR	COUNTER	GPL	GALVANIZED IRON	PCC	PRE-CAST CONCRETE	WC	WATER CLOSET
CPT	CARPET	HB	HOSE BIBB	PL	LATE	WD	WOOD
CT	CERAMIC TILE	HC	HOLLOW CORE	PLAM	PLASTIC LAMINATE	W/O	WITHOUT
COMPO	COMPOSITION/COMPOSITE	HDW	HARDWOOD	PLAS	PLASTER	WP	WATERPROOF
CMU	CONCRETE MASONRY UNIT	HM	HARDWARE	PLYWD	PLYWOOD	WSC	WAINSCOT
CONF	CONFERENCE	HORIZ	HOLLOW METAL	PR	PAIR	WT	WEIGHT
CMP	CORRIGATED METAL PIPE	HR	HORIZONTAL	PT	POINT	WH	WALL HUNG
CONTR	CONTRACTOR	HGT	HEIGHT	PTD	PAPER TOWEL DISPENSER	WWF	WELDED WIRE FABRIC
CP	CEMENT PLASTER	HC	HANDICAP	PAR	PARALLEL	WW	WIDE/WIDTH
CJ	CONTROL JOINT	HDR	HARDBOARD	PTN	PARTITION	WIN	WINDOW
DBL	DOUBLE	HVAC	HEADER HEATING, VENTING/ & AIR CONDITIONING	PL	PROPERTY LINE	WB	WOOD BASE
DEPT	DEPARTMENT	HD	HOLE	PERF	PERFORATED	QT	QUARRY TILE
DF	DRINKING FOUNTAIN	HOR	HEAVY DUTY	R	RISER	R	RADIUS
DET	DETAIL	HW	HORIZONTAL	RD	ROOF DRAIN	REF	REFERENCE
DIA	DUAL GLASS	HW	HOT WATER HEATER	REFR	REFRIGERATOR	RGTR	REGISTER
DIA	DIAMETER	HEX	HEXAGONAL	REINF	REINFORCEMENT	REQ	REQUIRED
DIM	DIMENSION	ID	INSIDE DIAMETER	RESIL	RESILIENT	RESIL	RESILIENT
DISP	DISPENSER	INT	INSULATION	RM	ROOM	RO	ROUGH OPENING
DN	DOWN	INCL	INTERIOR	RWD	REDWOOD	REV	REVISION
DO	DOOR OPENING	INSTR	INTEGRATED INSTRUCTIONS	RFEC	RECESSED FIRE EXTINGUISHER		
DWR	DRAWER	JAN	JANITORS	RET	RETURN	RH	RIGHT HAND
DS	DOWN SPOUT	JT	JOINT	RF	ROOF	RS	RESAWN
DSP	DRY STAND PIPE	JF	JOIST				
DWG	DRAWING	DW	DISHWASHER				
DP	DAMP PROOFING						
DEMO	DEMOLITION						
DEP	DEPRESSION/DEPRESSED						
DIAG	DIAGONAL						
DIV	DIVISION						
DR	DOOR						
D	DRAIN						

ABBREVIATIONS

DESIGN PROFESSIONAL IN GENERAL RESPONSIBLE CHARGE STATEMENT: THE POT IDENTIFIED IN THESE CONSTRUCTION DOCUMENTS IS COMPLIANT WITH THE CURRENT APPLICABLE CALIFORNIA BUILDING CODE ACCESSIBILITY PROVISIONS FOR PATH OF TRAVEL REQUIREMENTS FOR ALTERATIONS, ADDITIONS AND STRUCTURAL REPAIRS. AS PART OF THE DESIGN OF THIS PROJECT, THE POT WAS EXAMINED AND ANY ELEMENTS, COMPONENTS OR PORTIONS OF THE POT THAT WERE DETERMINED TO BE NONCOMPLIANT 1) HAVE BEEN IDENTIFIED AND 2) THE CORRECTIVE WORK NECESSARY TO BRING THEM INTO COMPLIANCE HAS BEEN INCLUDED WITHIN THE SCOPE OF THIS PROJECT'S WORK THROUGH DETAILS, DRAWINGS AND SPECIFICATIONS INCORPORATED INTO THESE CONSTRUCTION DOCUMENTS. ANY NONCOMPLIANT ELEMENTS, COMPONENTS OR PORTIONS OF THE POT THAT WILL NOT BE CORRECTED BY THIS PROJECT BASED ON VALUATION THRESHOLD LIMITATIONS OR A FINDING OF UNREASONABLE HARDSHIP ARE SO INDICATED IN THESE CONSTRUCTION DOCUMENTS. DURING CONSTRUCTION, IF POT ITEMS WITHIN THE SCOPE OF THE PROJECT REPRESENTED AS CODE COMPLIANT ARE FOUND TO BE NONCONFORMING BEYOND REASONABLE CONSTRUCTION TOLERANCES, THEY SHALL BE BROUGHT INTO COMPLIANCE WITH THE CBC AS A PART OF THIS PROJECT BY MEANS OF A CONSTRUCTION CHANGE DOCUMENT.

ACCESSIBLE PATH OF TRAVEL AS INDICATED ON PLAN IS A BARRIER-FREE ACCESS ROUTE WITHOUT ANY ABRUPT LEVEL CHANGES EXCEEDING 1/4" IF BEVELED AT 1:2 MAX SLOPE, OR VERTICAL LEVEL CHANGES NOT EXCEEDING 1/4" MAX. AND AT LEAST 48" IN WIDTH. SURFACE IS STABLE, FIRM, AND SLIP RESISTANT. CROSS SLOPE DOES NOT EXCEED 2.1% AND SLOPE IN THE DIRECTION OF TRAVEL IS LESS THAN 5%, UNLESS OTHERWISE INDICATED. ACCESSIBLE PATH OF TRAVEL SHALL BE MAINTAINED FREE OF OVERHANGING OBSTRUCTIONS TO 80" MINIMUM, AND PROTRUDING OBJECTS GREATER THAN 4" PROJECTION FROM WALL AND ABOVE 27" AND LESS THAN 80".

WALKS AND SIDEWALKS: ALL WALKS AND SIDEWALKS THAT ARE INDICATED AS PATH OF TRAVEL SHALL BE BARRIER-FREE ACCESS ROUTE WITHOUT ANY ABRUPT VERTICAL CHANGES EXCEEDING 1/4" (CBC 11B-403.3)

DRINKING FOUNTAINS: ALL DRINKING FOUNTAINS SHALL CONFORM TO CBC.

GRATINGS: FOR GRATINGS LOCATED IN THE SURFACE OF ANY PEDESTRIAN WAY IN THE PATH OF TRAVEL, GRID/OPENING IN THE GRATINGS SHALL NOT ALLOW PASSAGE OF A SPHERE MORE THAN 1/2" DIAMETER. IF SUCH CONDITION OCCURS, PROVIDE MANUFACTURERS CUT SHEETS FOR REVIEW.

ACCESSIBILITY NOTES

CLIENT



Palo Verde Community College District
1 College Drive
Blythe, CA 92225

PROJECT NAME

Project 2
College Services Building
1 College Drive
Blythe, CA 92225

CONTRACTOR

DESIGNER

31045 Temecula Parkway
Suite 204
Temecula, CA 92592
T. 760.489.4432
www.sillmanwright.com

CONSULTANTS

REGISTRATION STAMP



ISSUE

Mark	Date	Description
△	3/24/2018	ADDENDUM 2

DESIGNER PROJECT NO.: 17009

DRAWN BY: Author

CHECKED BY: Checker

SCALE: 1/16" = 1'-0"

DESIGN ITERATION 10/06/17

DSA Submittal 10/06/2017

DATE 10/06/17

SHEET TITLE

NOTES, ABBREVIATIONS, AND ACCESSIBILITY NOTES

SHEET NUMBER


G-002



Mark	Date	Description
▲	3/24/2018	ADDENDUM 2

OVERALL SECOND FLOOR PLAN

G-004

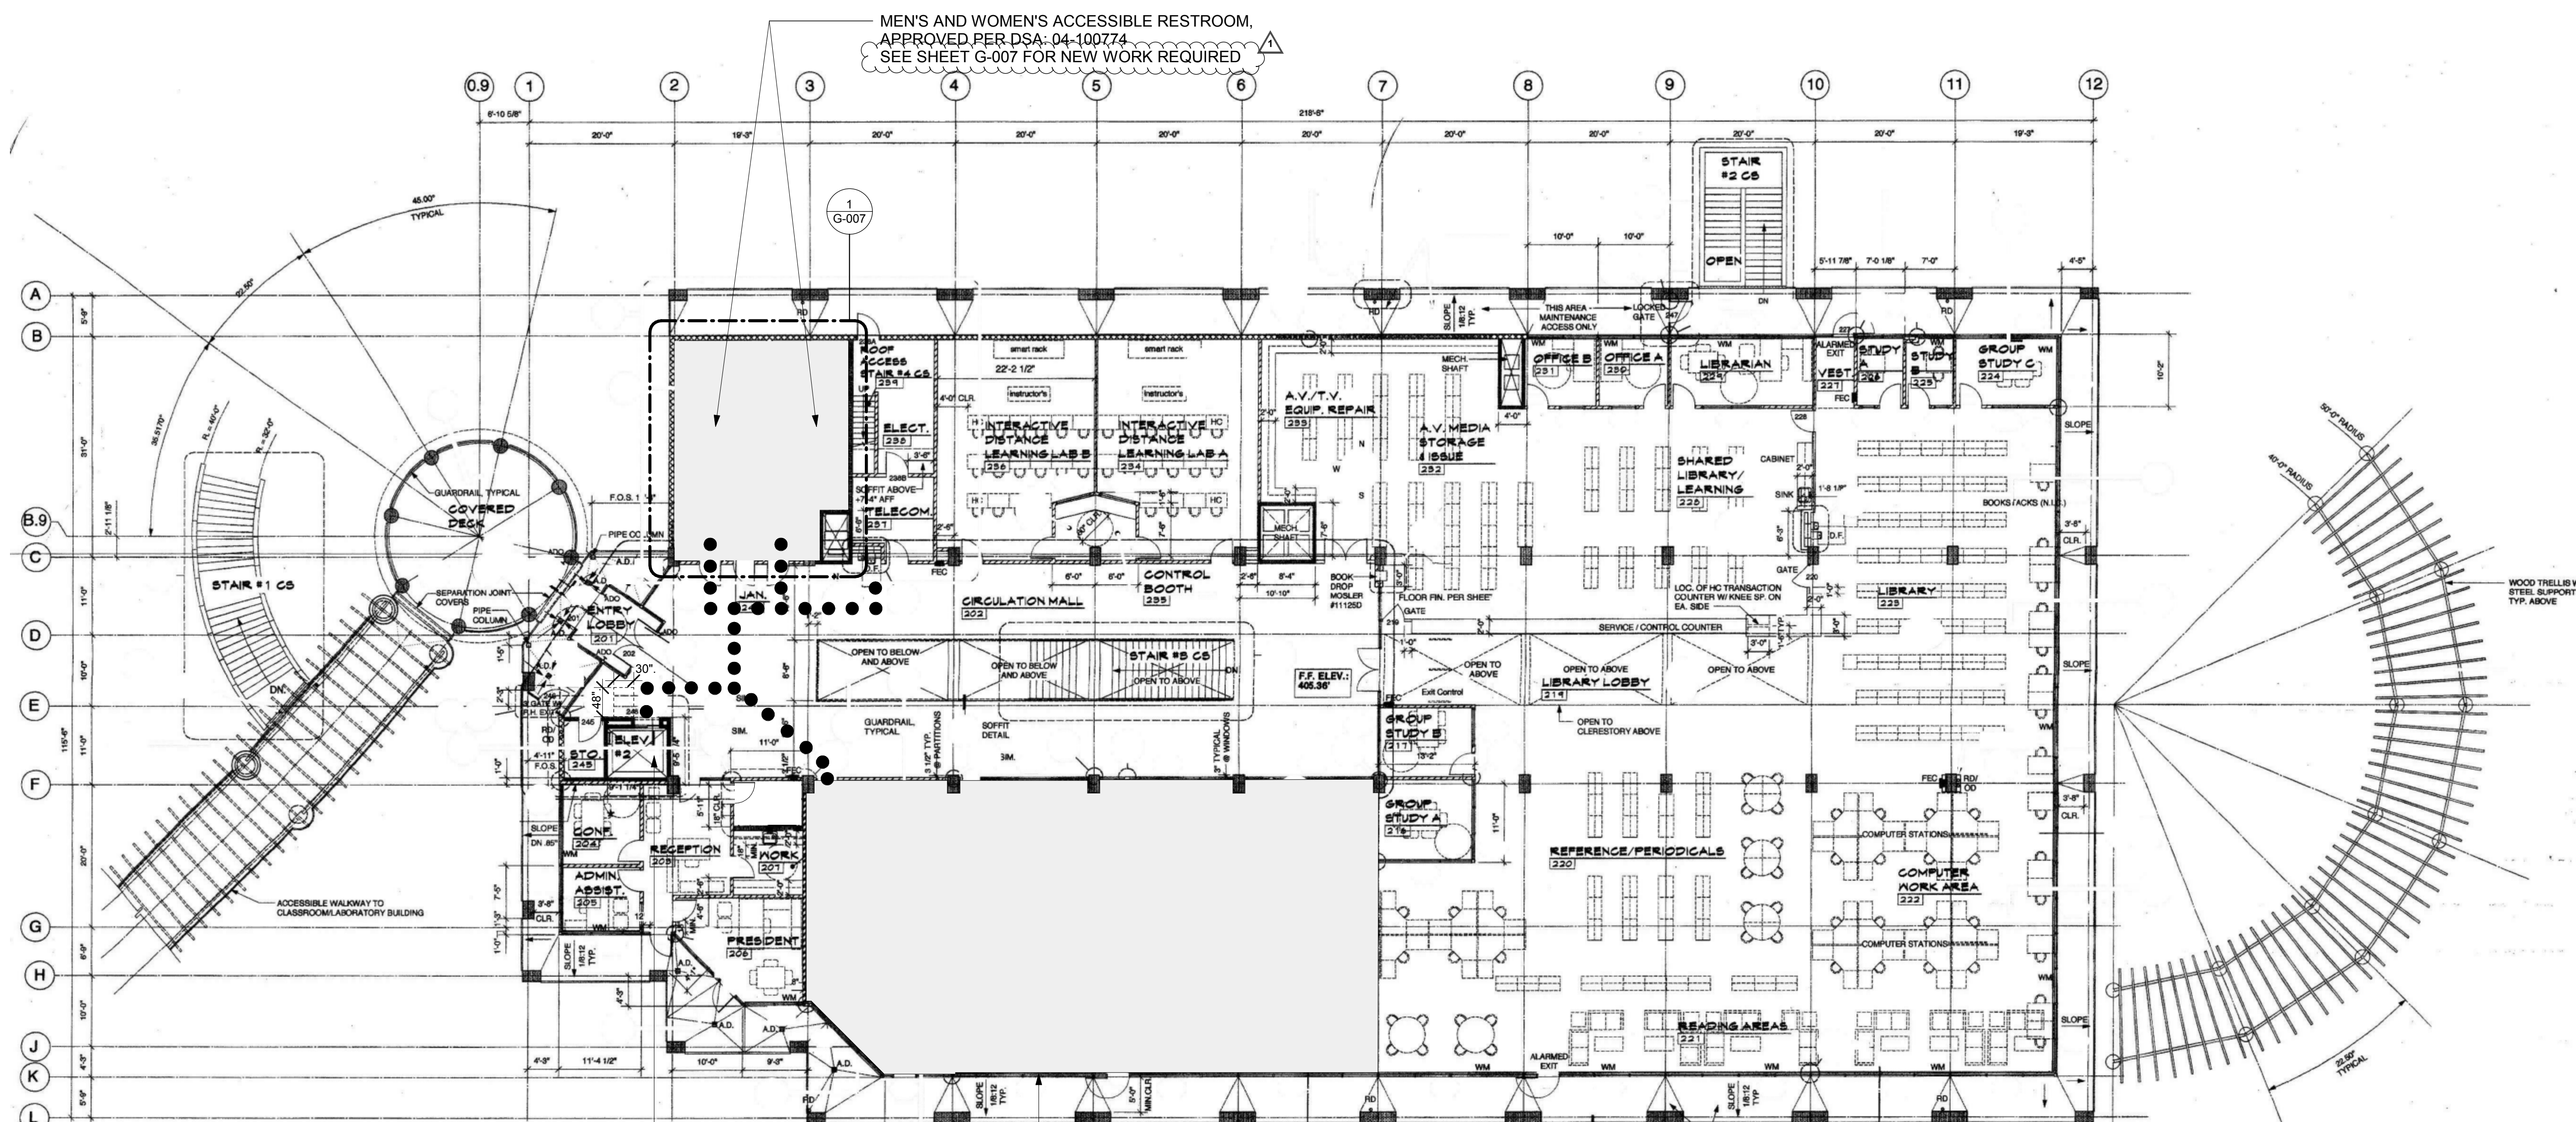

EXISTING ELEVATOR,
APPROVED PER DSA-04-100774


MEN'S AND WOMEN'S ACCESSIBLE RESTROOM,
APPROVED PER DSA-04-100774,
SEE SHEET G-007 FOR NEW WORK REQUIRED

AREA OF WORK
COLLEGE SERVICES BUILDING,
TENANT IMPROVEMENT
SEE A-200


●●●●● INDICATES (E) PATH OF TRAVEL (P.O.T.)
PER DSA 04-100774

ACCESSIBLE PATH OF TRAVEL AS DEFINED BELOW:


ACCESSIBLE PATH OF TRAVEL AS INDICATED ON PLAN IS A BARRIER-FREE ACCESS ROUTE WITHOUT ANY ABRUPT LEVEL CHANGES THAT WILL BE GREATER THEN 1/2" WHEN CHANGES TO OCCUR, THEY SHALL BE BEVELED WITH A MAX. SLOPE OF 1:2. LEVEL CHANGES LESS THAN A 1/4" MAX MAY BE VERTICAL, AND AT LEAST 48" IN WIDTH. SURFACE IS STABLE, FIRM, AND SLIP RESISTANT. THE MAXIMUM PERMITTED CROSS SLOPE SHALL NOT EXCEED 1:48, AND SLOPE IN THE DIRECTION OF TRAVEL IS LESS THAN 5%, IF GREATER THAN 5% THEY MUST COMPLY RAMP REQUIREMENTS PER SECTION 11B-402.2. ACCESSIBLE PATH OF TRAVEL SHALL BE MAINTAINED FREE OF OVERHANGING OBSTRUCTIONS TO 80" MINIMUM, AND PROTRUDING OBJECTS GREATER THAN 4" PROJECTION FROM WALL AND ABOVE 27" AND LESS THAN 80". ARCHITECT SHALL VERIFY THAT THERE ARE NO BARRIERS IN THE PATH OF TRAVEL.

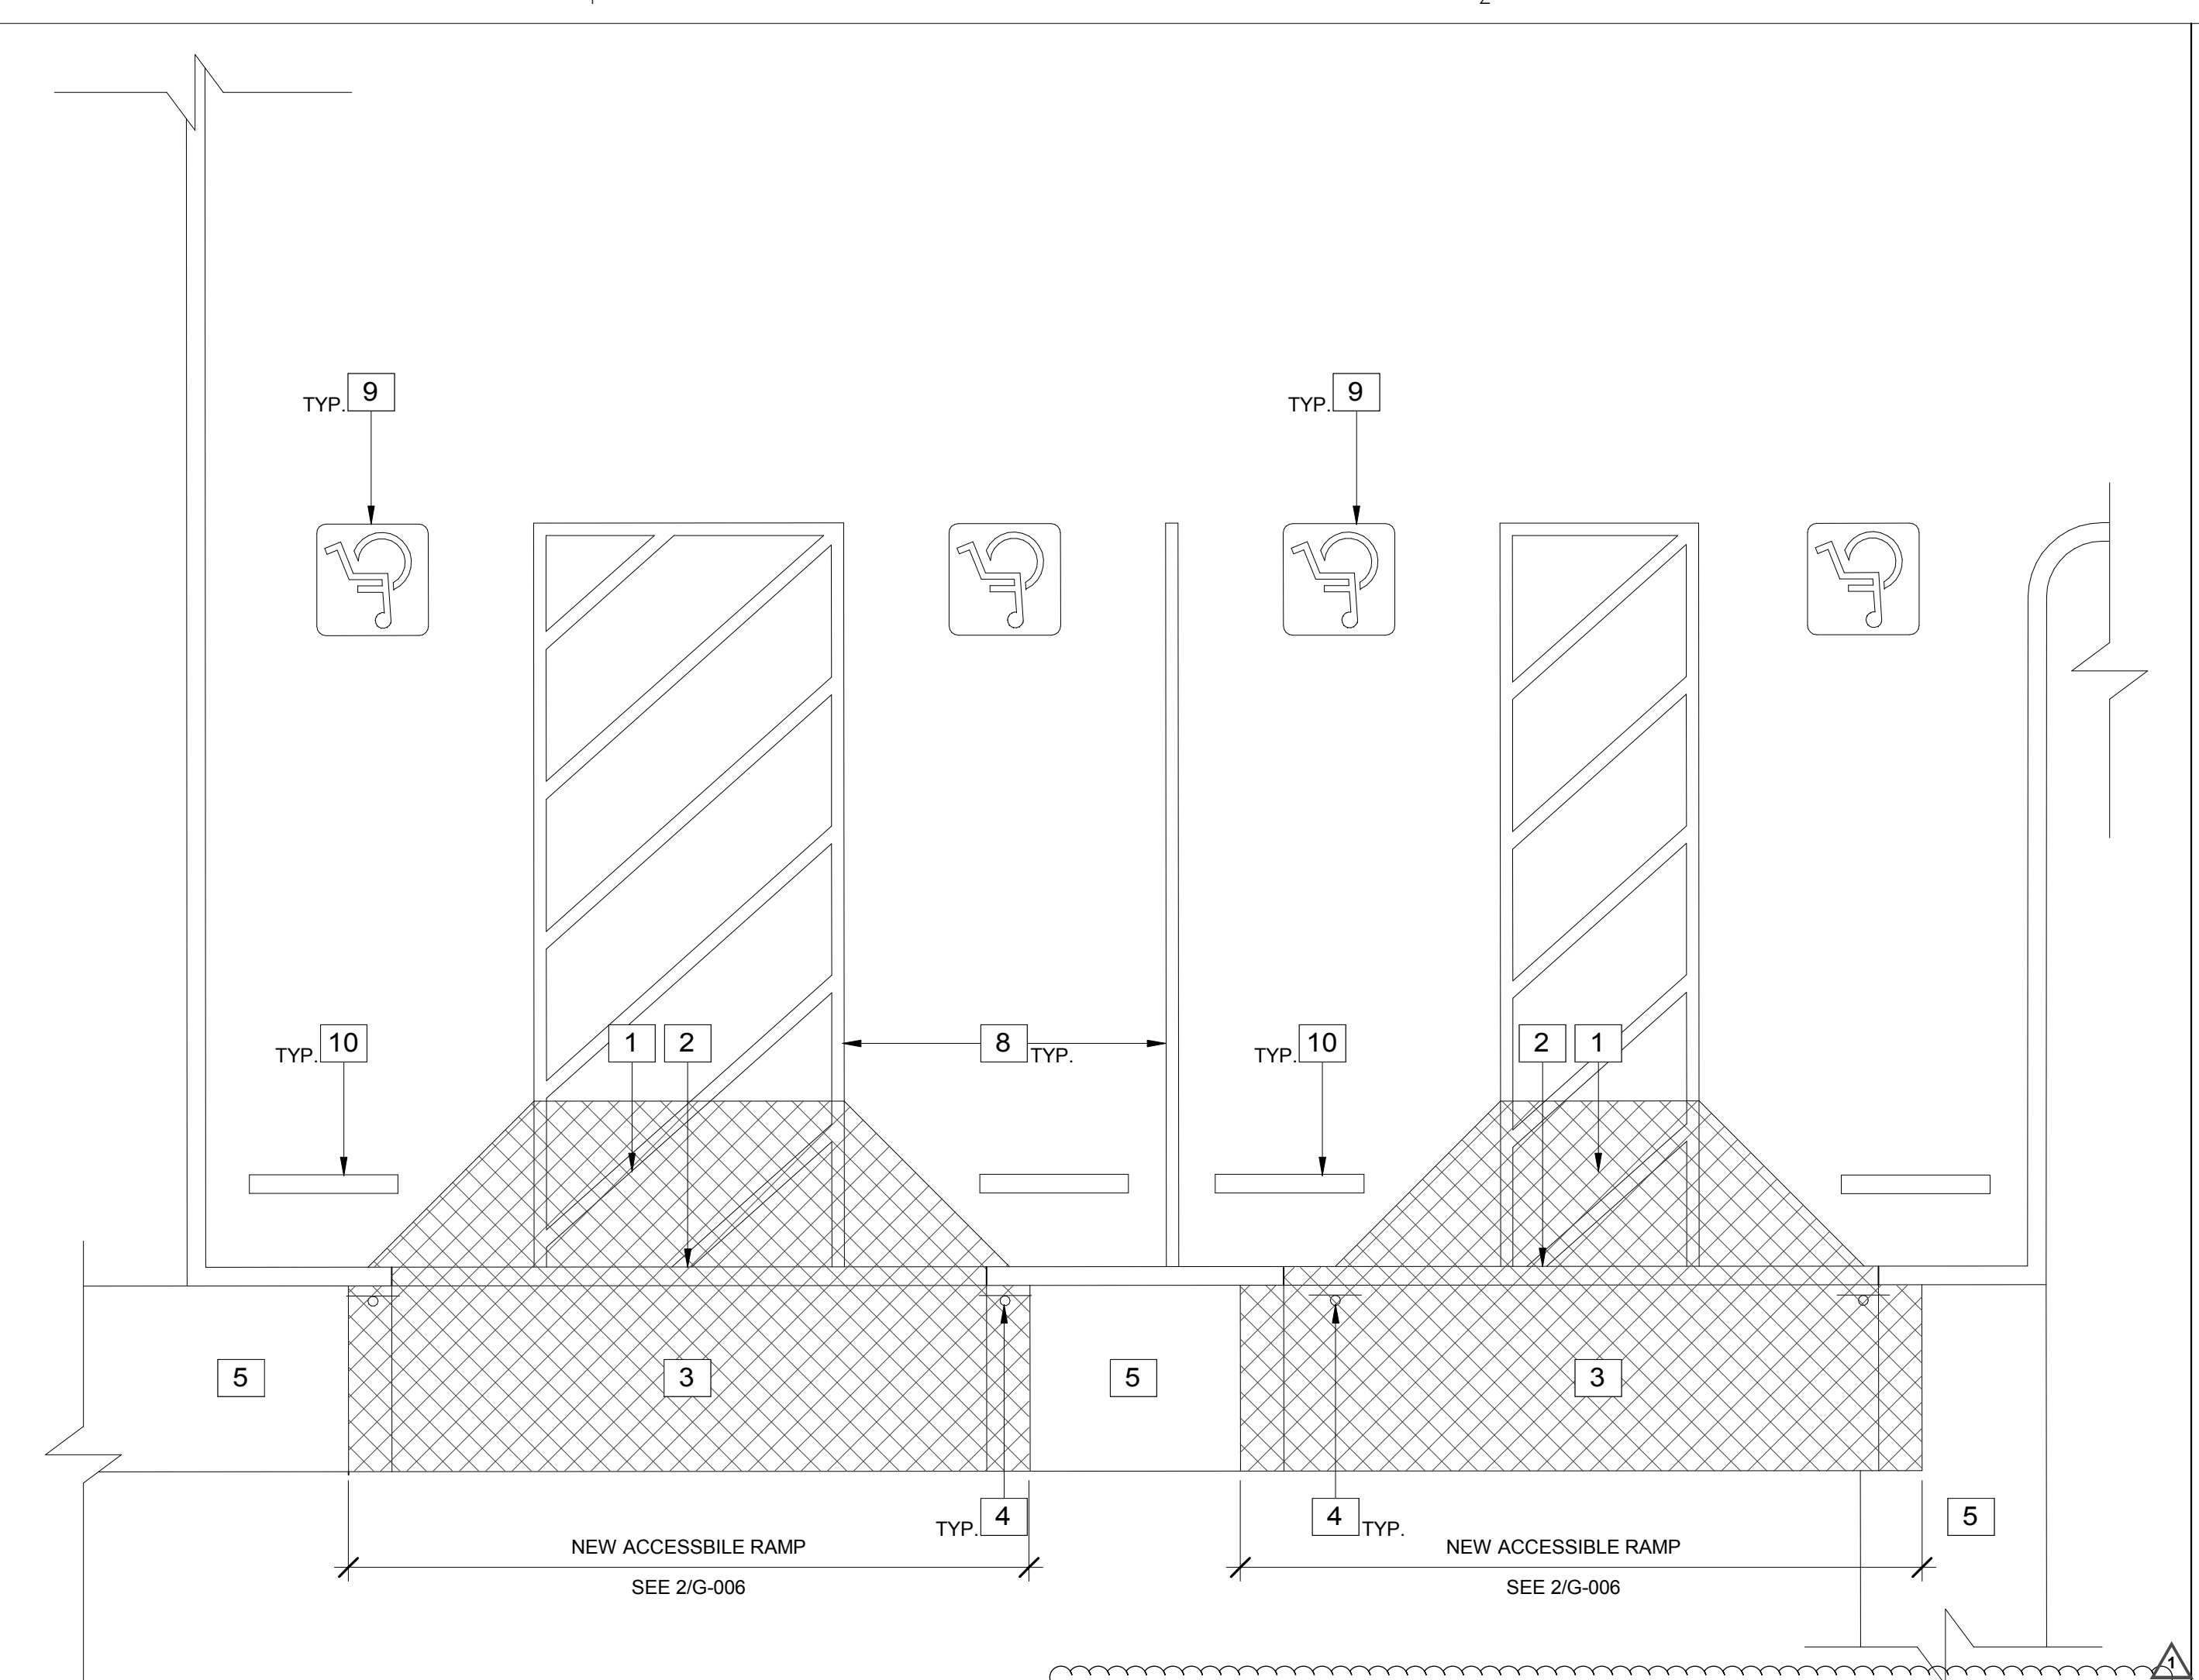

COLLEGE SERVICES BUILDING DEMOLITION ACCESSIBLE PATH 2
1/4" = 1'-0" 2

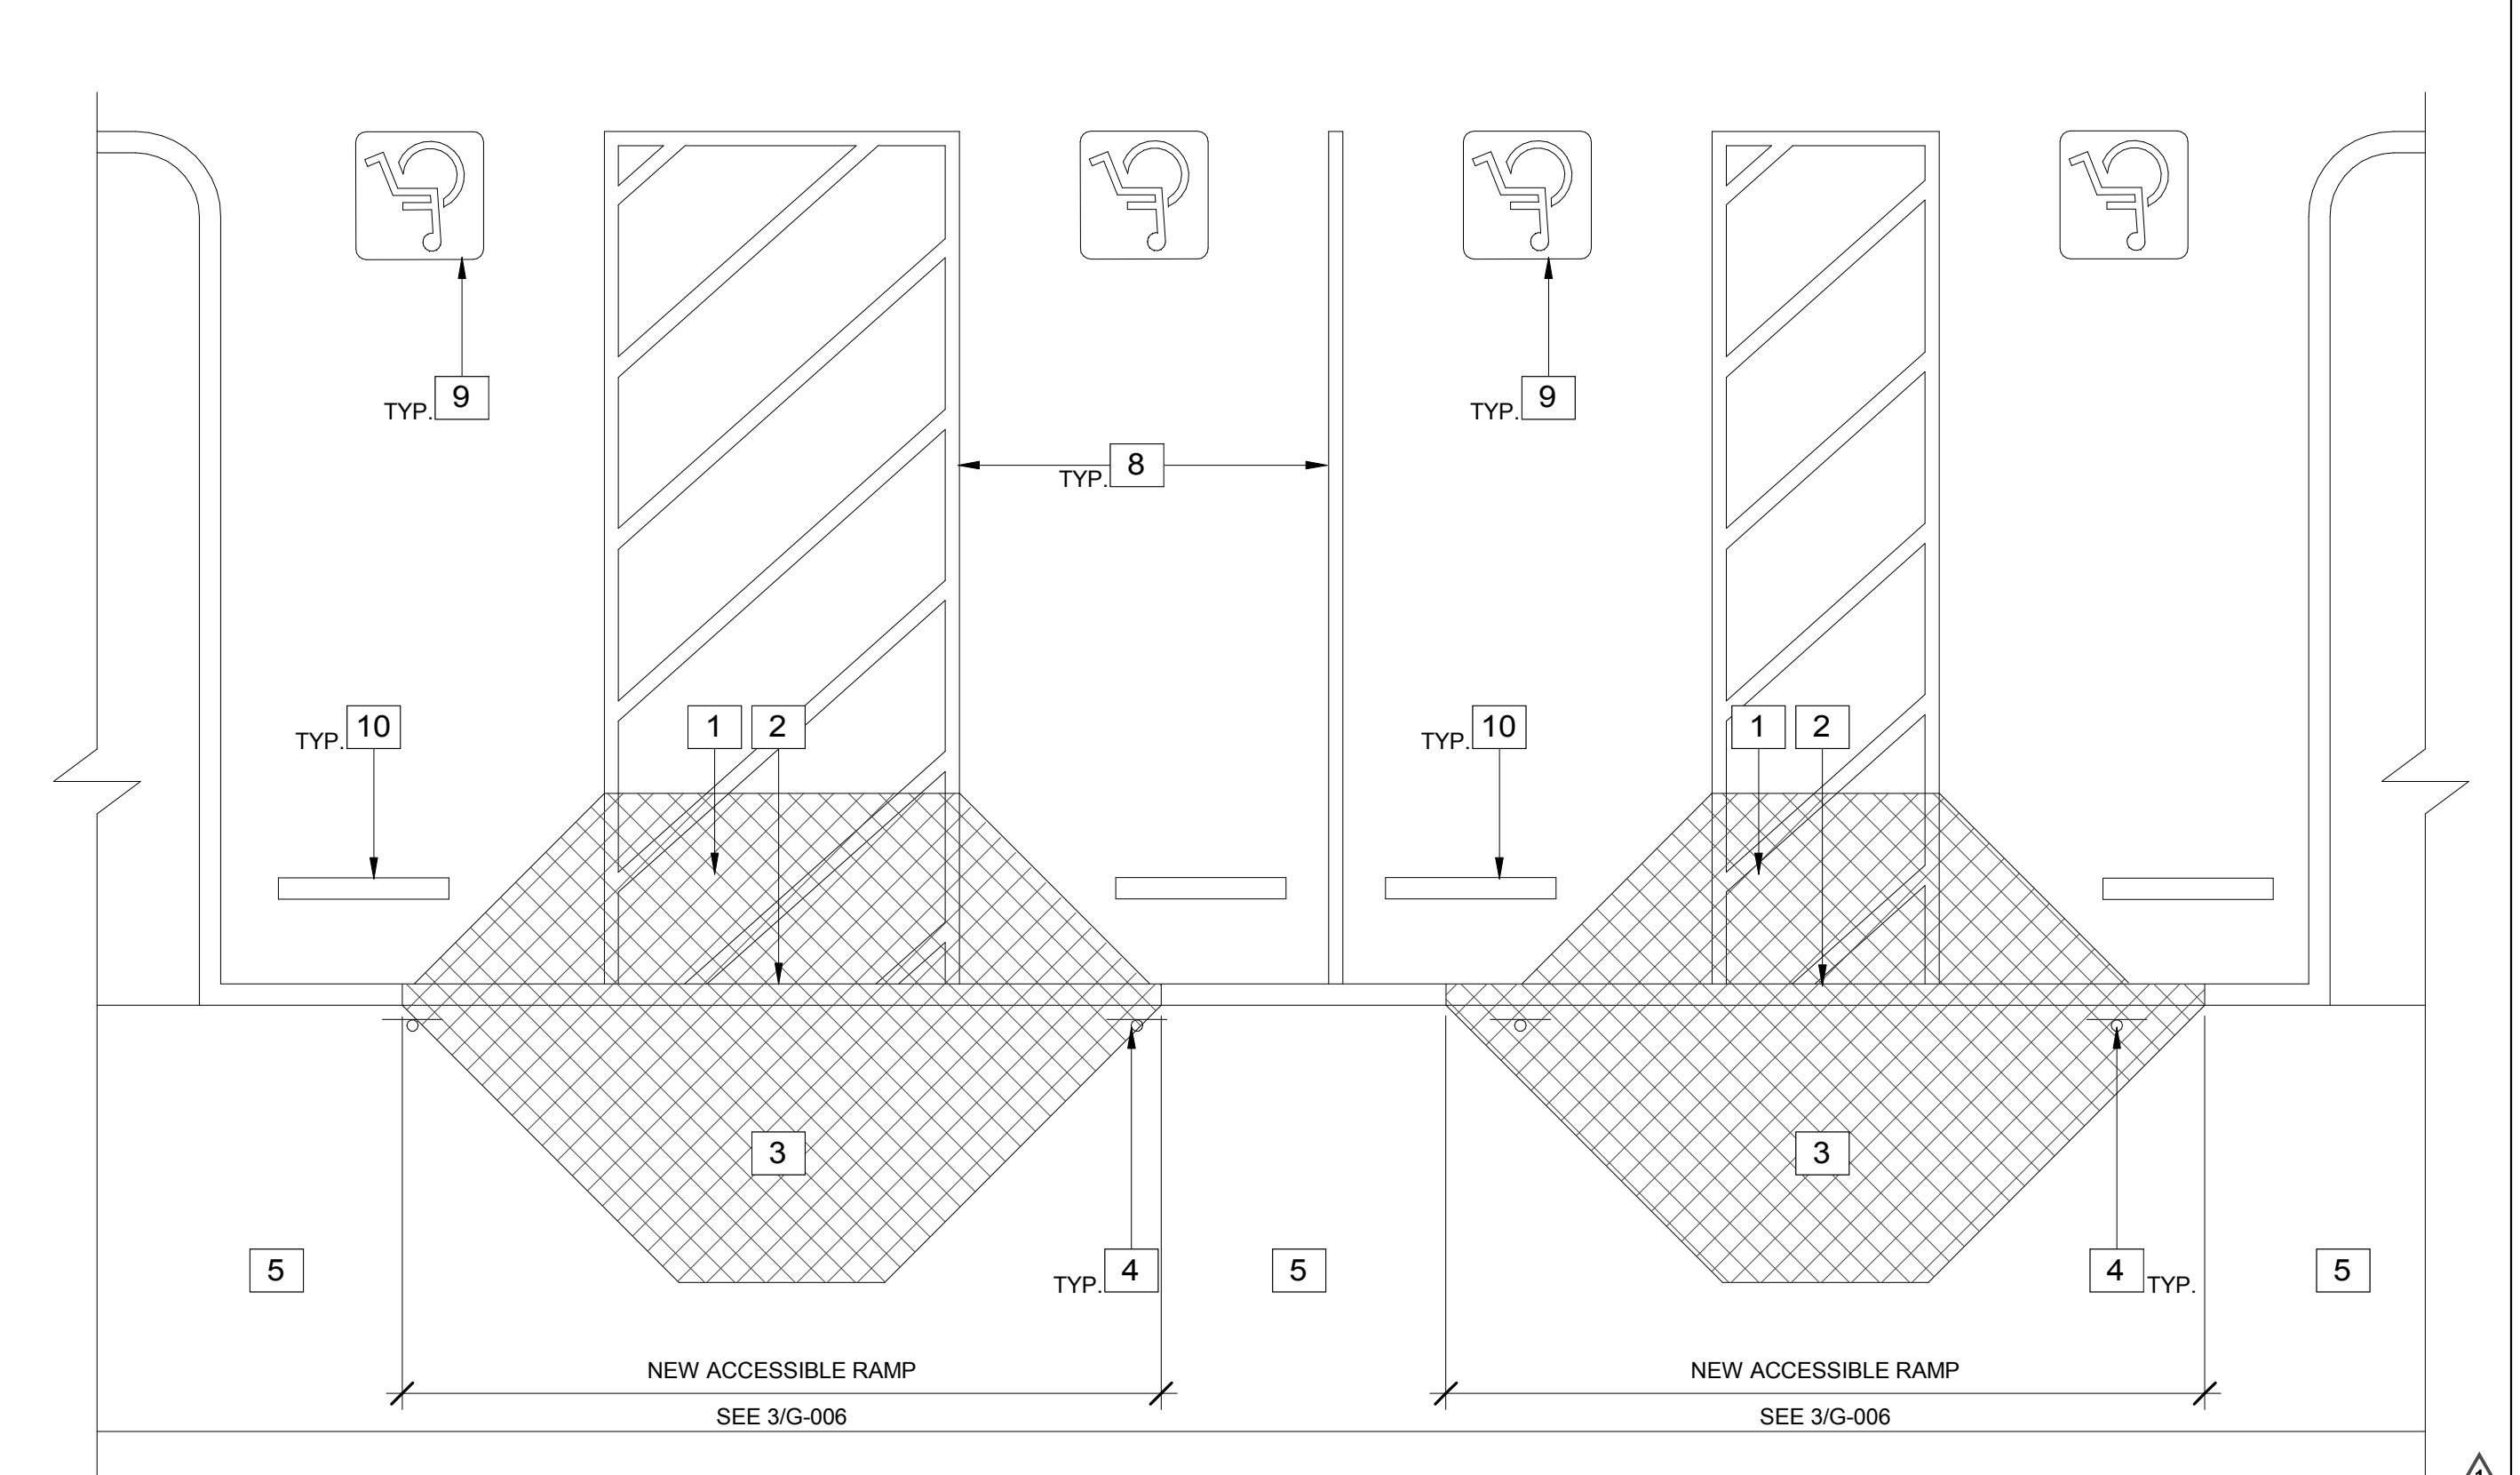

COLLEGE SERVICES BUILDING DEMOLITION ACCESSIBLE PATH 3
1/4" = 1'-0" 3

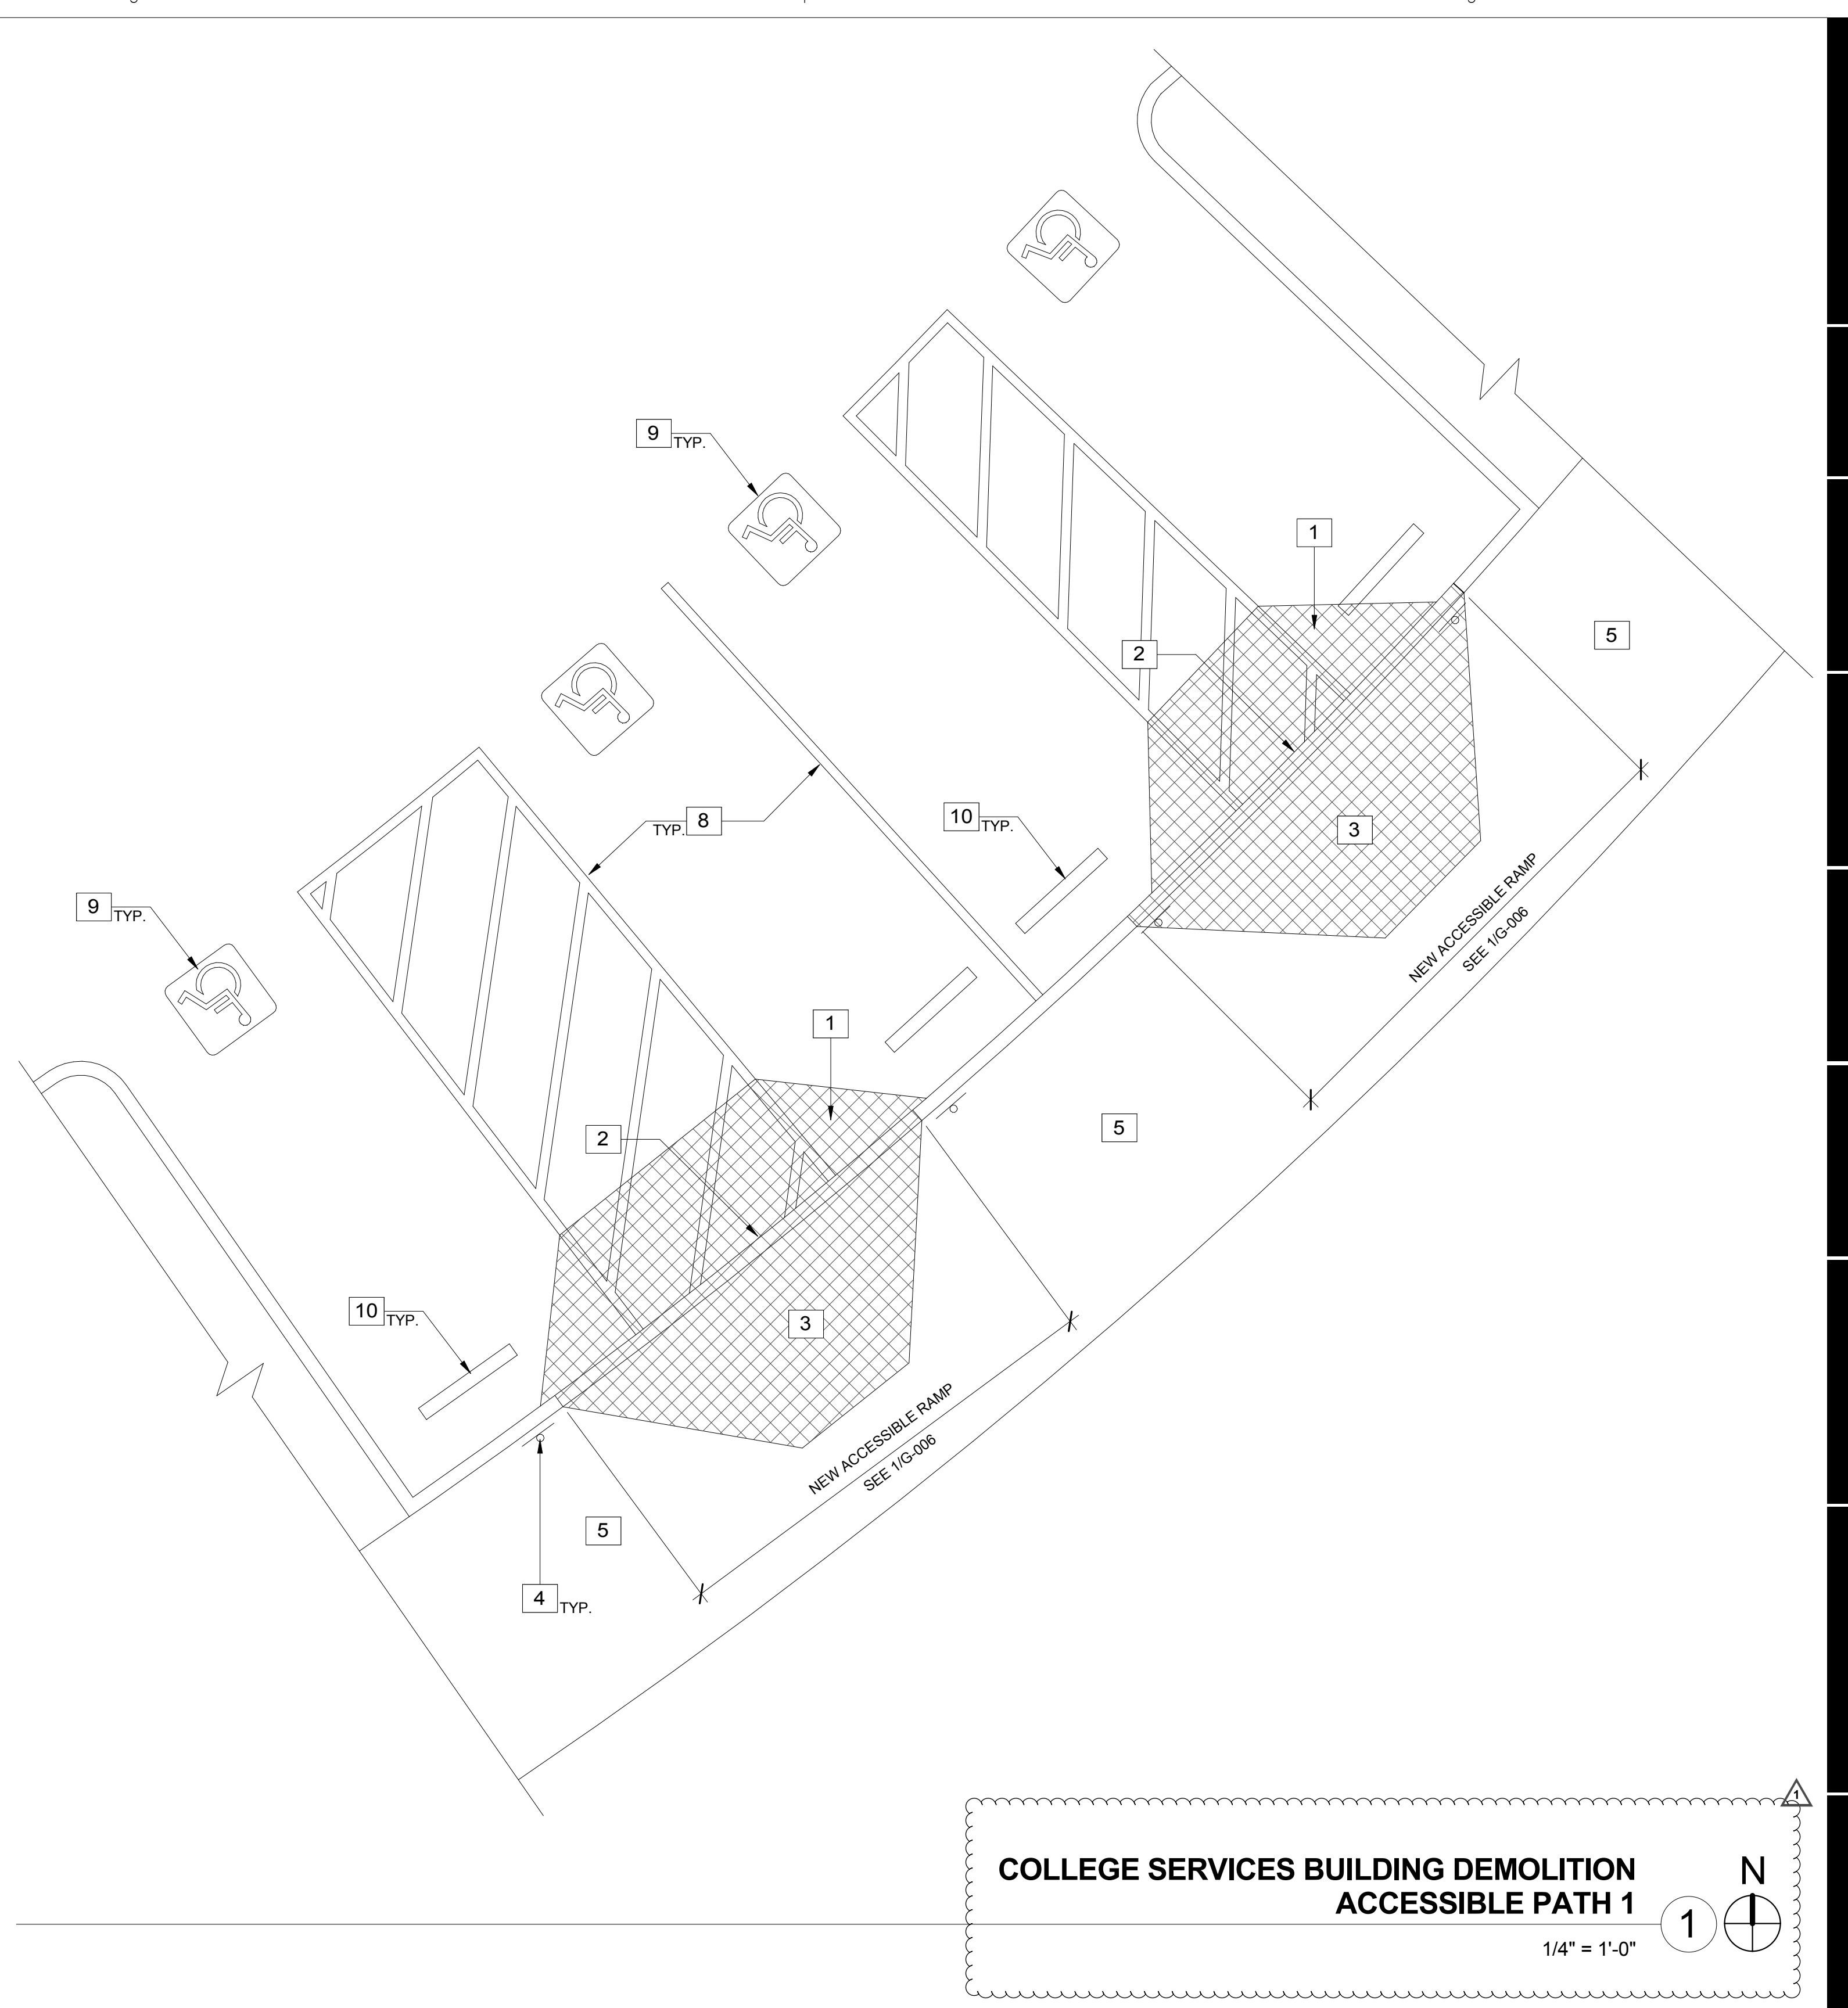

COLLEGE SERVICES BUILDING DEMOLITION ACCESSIBLE PATH 1
1/4" = 1'-0" 1

- KEYNOTES**
- 1 DEMOLISH EXISTING ACCESSIBLE RAMP, SEE G-006
 - 2 NEW ACCESSIBLE CURB CUT PER G-006
 - 3 DEMOLISH SIDEWALK PER G-006
 - 4 RELOCATE ALL ACCESSIBLE STALL SIGNAGE PER G-006
 - 5 EXISTING SIDEWALK TO REMAIN, N.I.C.
 - 6 INTENTIONALLY LEFT BLANK
 - 7 INTENTIONALLY LEFT BLANK
 - 8 EXISTING STRIPING TO REMAIN, N.I.C.
 - 9 EXISTING DISABLED PARKING SYMBOL TO REMAIN, N.I.C.
 - 10 EXISTING WHEEL STOP TO REMAIN, N.I.C.

LEGEND

..... EXISTING ACCESSIBLE PATH OF TRAVEL

▨ AREA TO BE DEMOLISHED

ACCESSIBLE PATH OF TRAVEL AS DEFINED BELOW:

ACCESSIBLE PATH OF TRAVEL AS INDICATED ON PLAN IS A BARRIER-FREE ACCESS ROUTE WITHOUT ANY ABRUPT LEVEL CHANGES THAT WILL BE GREATER THEN 1/2" WHEN CHANGES TO OCCUR, THEY SHALL BE BEVELED WITH A MAX. SLOPE OF 1:2. LEVEL CHANGES LESS THAN A 1/4" MAX MAY BE VERTICAL, AND AT LEAST 48" IN WIDTH. SURFACE IS STABLE, FIRM, AND SLIP RESISTANT. THE MAXIMUM PERMITTED CROSS SLOPE SHALL NOT EXCEED 1:48, AND SLOPE IN THE DIRECTION OF TRAVEL IS LESS THAN 5%, IF GREATER THAN 5% THEY MUST COMPLY RAMP REQUIREMENTS PER SECTION 11B-402.2. ACCESSIBLE PATH OF TRAVEL SHALL BE MAINTAINED FREE OF OVERHANGING OBSTRUCTIONS TO 80" MINIMUM, AND PROTRUDING OBJECTS GREATER THAN 4" PROJECTION FROM WALL AND ABOVE 27" AND LESS THAN 80". ARCHITECT SHALL VERIFY THAT THERE ARE NO BARRIERS IN THE PATH OF TRAVEL.

CLIENT

PALO VERDE COLLEGE
WHERE KNOWLEDGE TAKES ROOT AND OPPORTUNITY GROWS

Palo Verde Community College District
1 College Drive
Blythe, CA 92225

PROJECT NAME

**Project 2
College Services Building
1 College Drive
Blythe, CA 92225**

CONTRACTOR

DESIGNER

SILLMAN WRIGHT ARCHITECTS 31045 Temecula Parkway Suite 204
Temecula, CA 92592 T. 760.489.4432 www.sillmanwright.com

CONSULTANTS

REGISTRATION STAMP

ISSUE

Mark	Date	Description
Δ	3/24/2018	ADDENDUM 2

DESIGNER PROJECT NO.: 17009

DRAWN BY: Author

CHECKED BY: Checker

SCALE: 1/4" = 1'-0"

DESIGN ITERATION 10/06/17

DSA Submittal 10/06/2017


DATE 10/06/17

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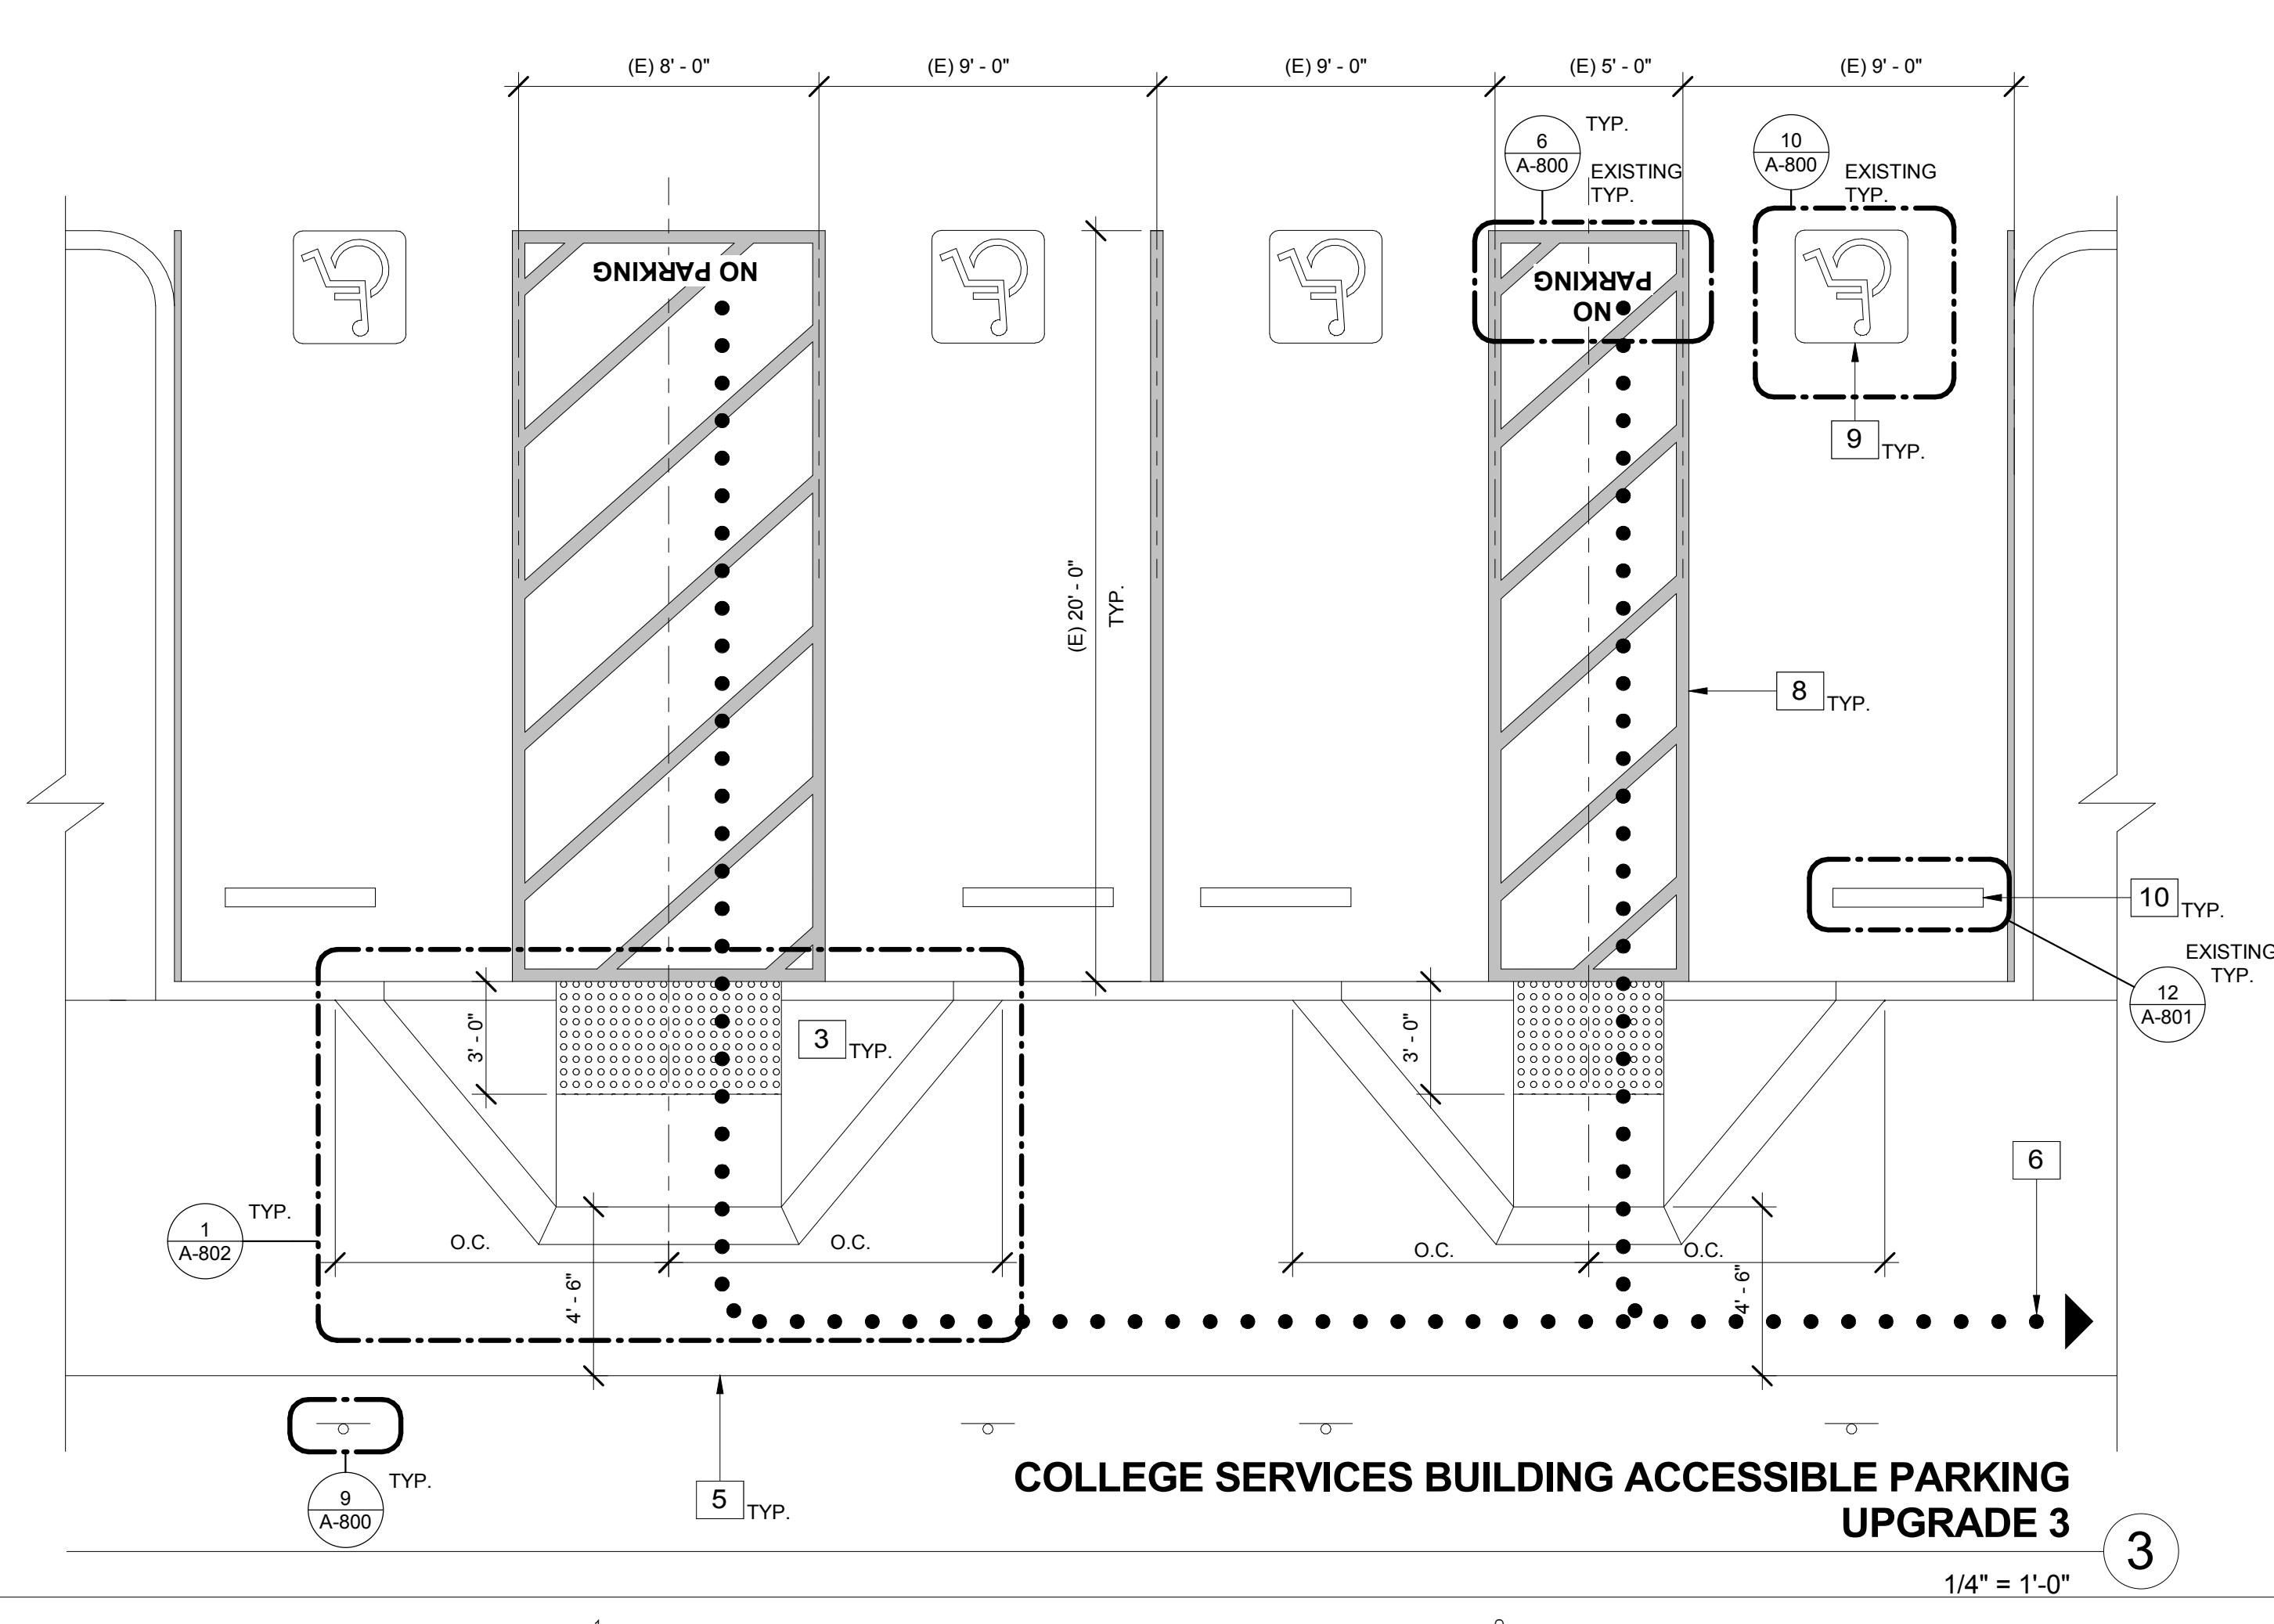
CS BUILDING ACCESSIBLE PARKING DEMOLITION

SHEET NUMBER


G-005

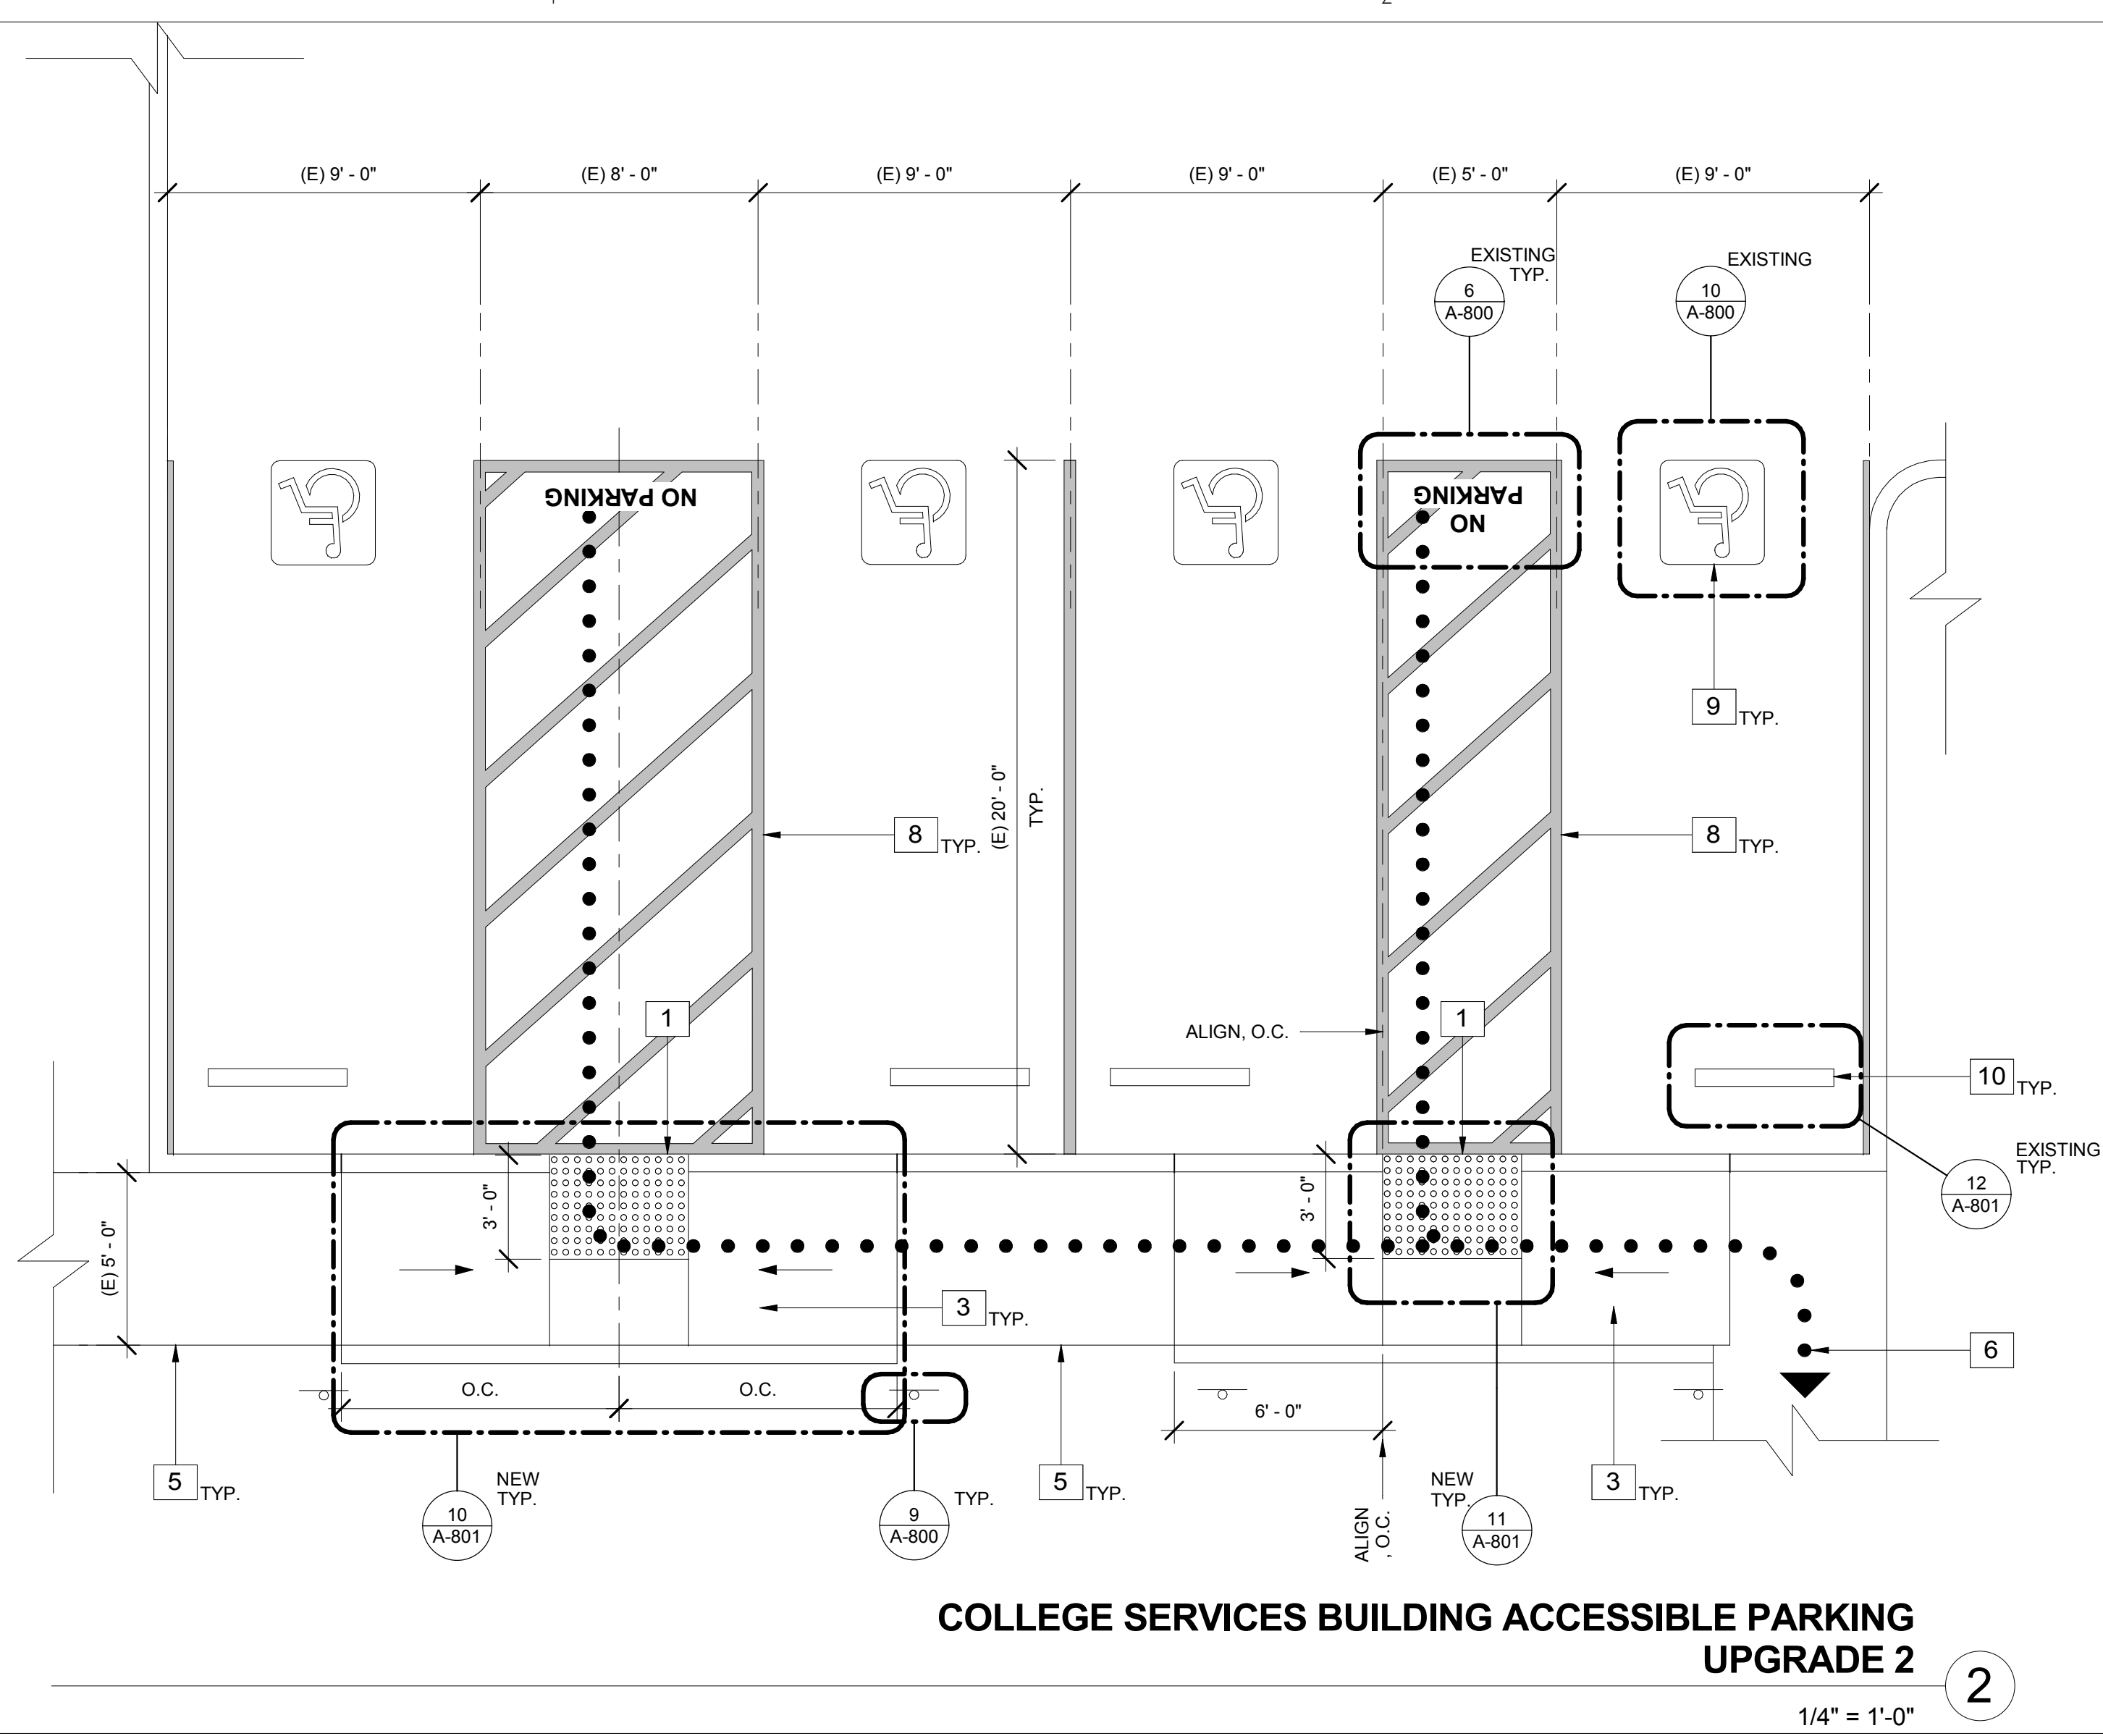

COLLEGE SERVICES BUILDING ACCESSIBLE PARKING UPGRADE 2
1/4" = 1'-0"



COLLEGE SERVICES BUILDING ACCESSIBLE PARKING UPGRADE 3
1/4" = 1'-0"

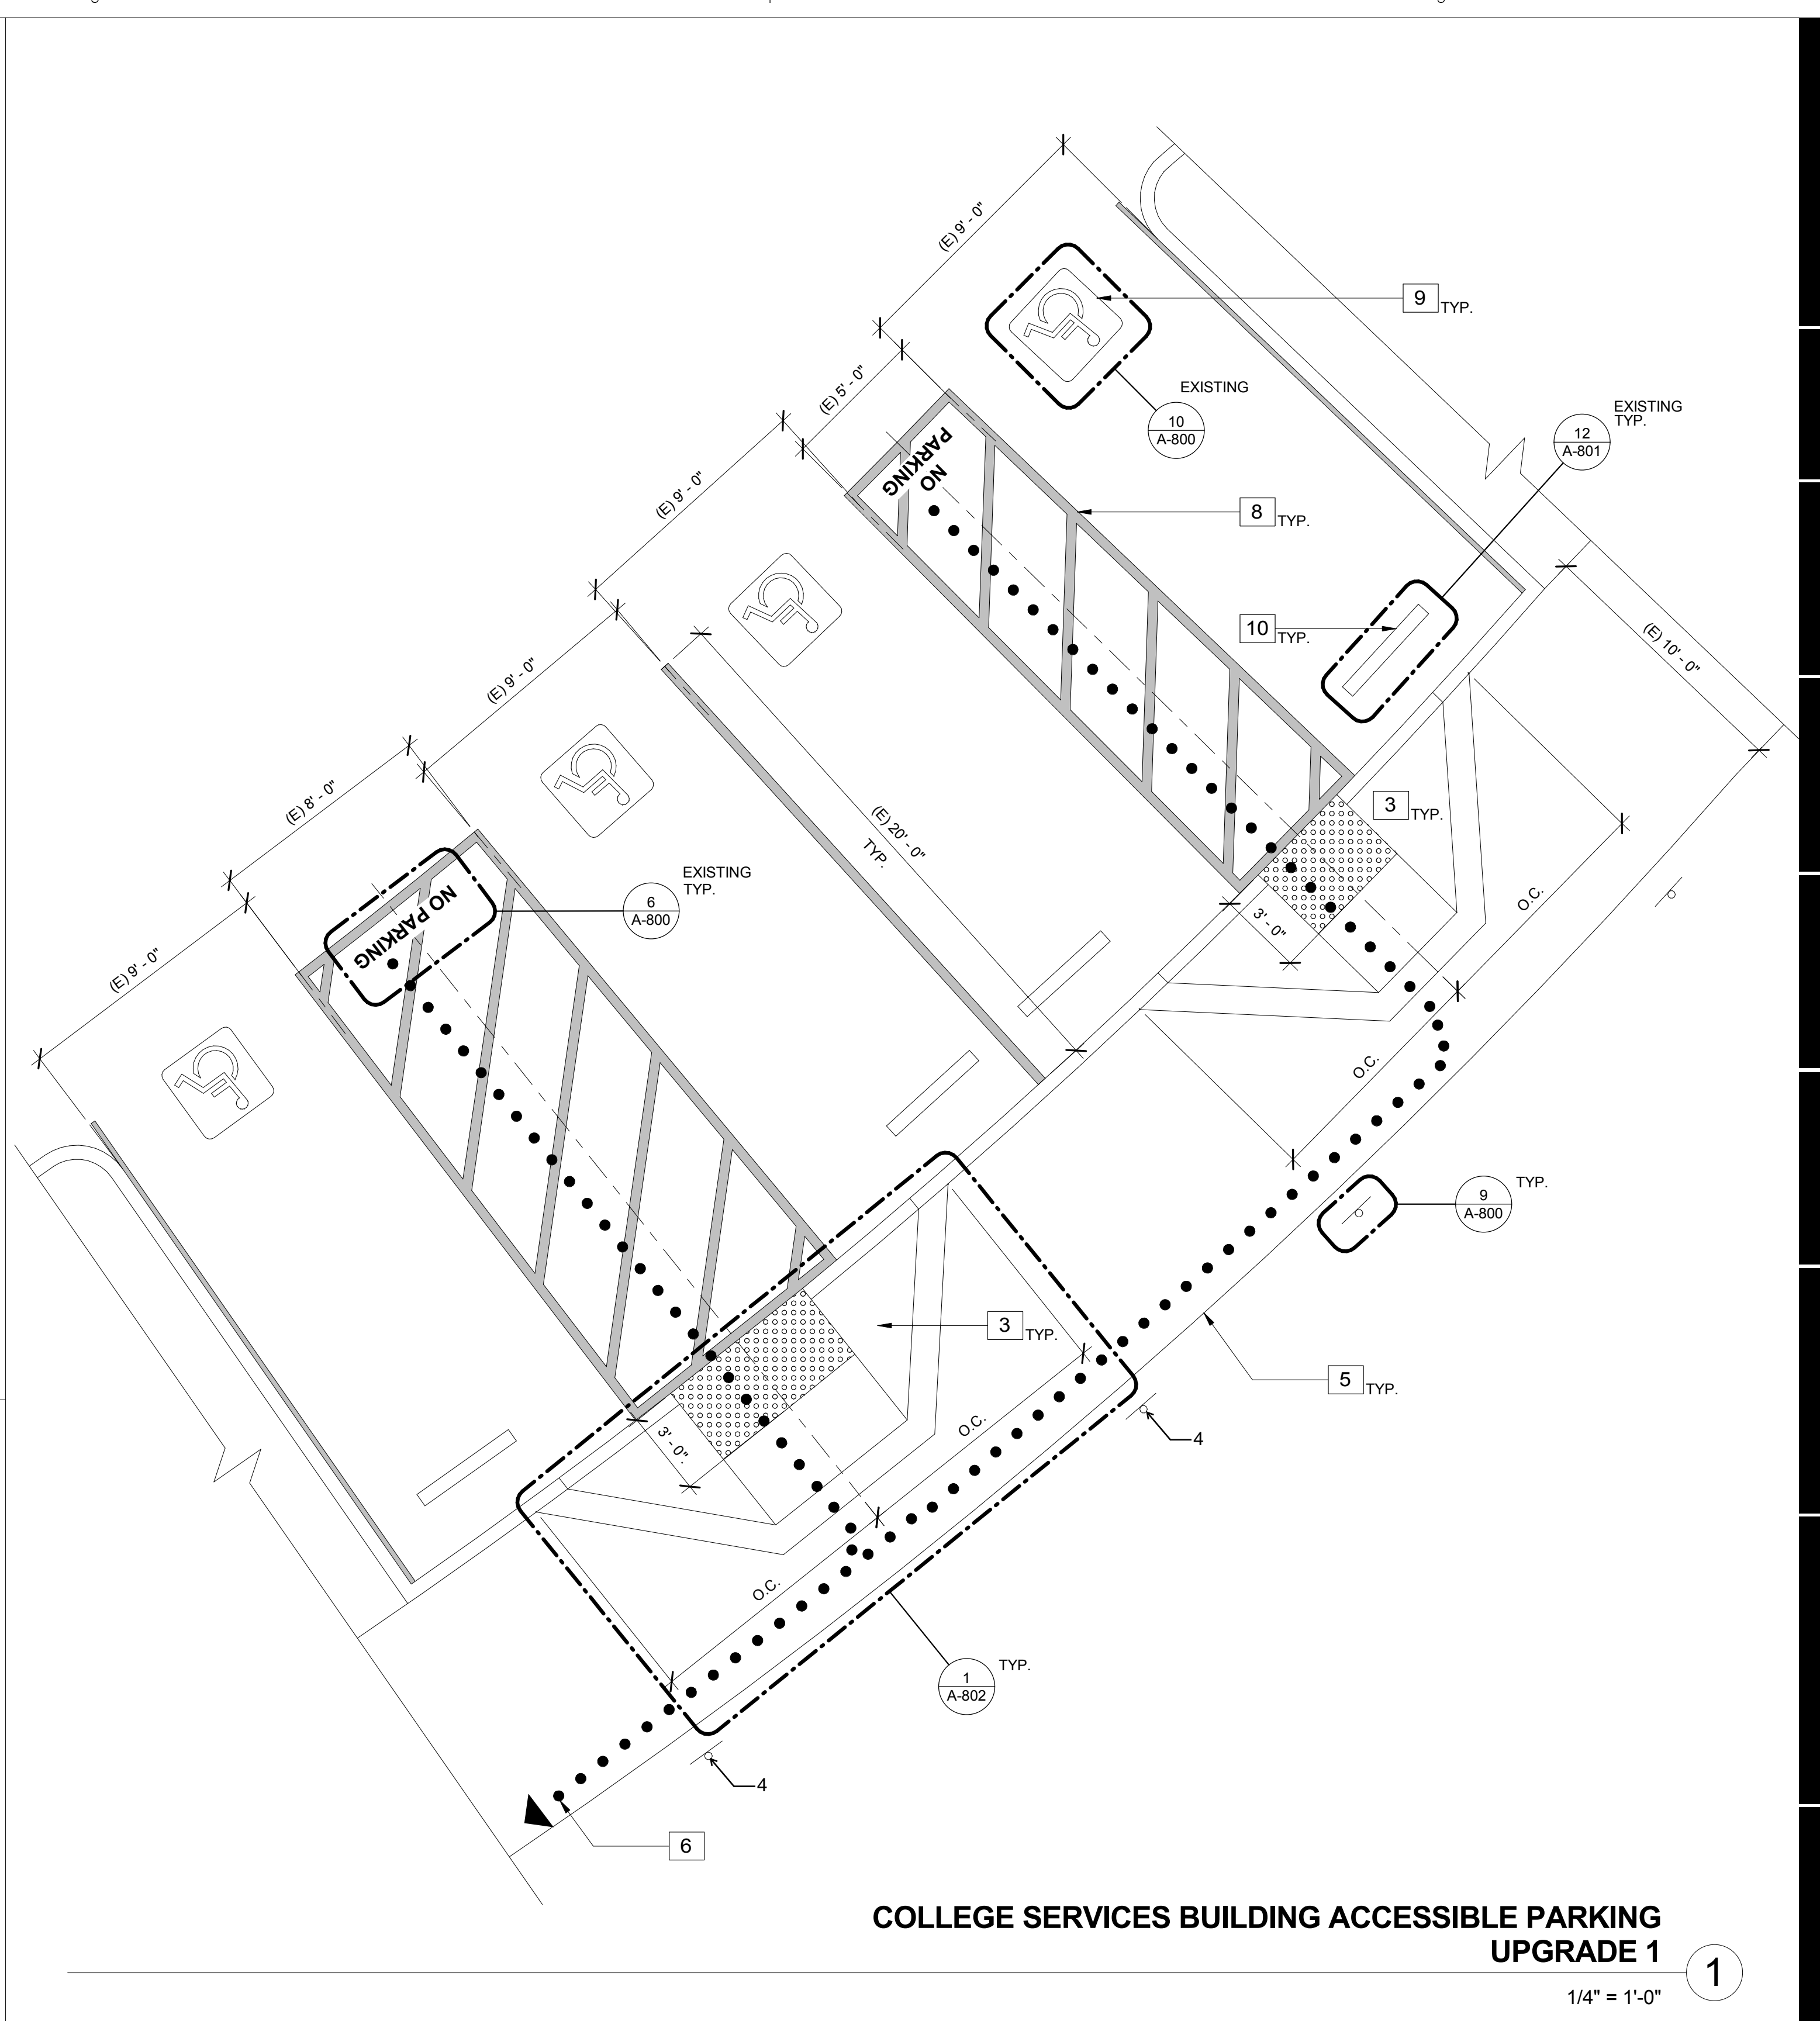

COLLEGE SERVICES BUILDING ACCESSIBLE PARKING UPGRADE 1
1/4" = 1'-0"

KEYNOTES

- 1 NEW P.O.T. PAVING FLUSH WITH PARKING SURFACE
- 2 NOT USED
- 3 NEW CONCRETE ACCESSIBLE CURB RAMP
- 4 RELOCATED ACCESSIBLE STALL SIGNAGE LOCATION
- 5 EXISTING WALKWAY TO REMAIN, N.I.C.
- 6 P.O.T. TO COLLEGE SERVICES BUILDING, SEE G-003
- 7 NOT USED
- 8 EXISTING BLUE STRIPING TO REMAIN, N.I.C.
- 9 EXISTING DISABLED PARKING SIGNAGE, N.I.C.
- 10 EXISTING WHEEL STOP TO REMAIN, N.I.C.

LEGEND

- EXISTING ACCESSIBLE PATH OF TRAVEL
- [Hatched Box] AREA TO BE DEMOLISHED

ACCESSIBLE PATH OF TRAVEL AS DEFINED BELOW:

ACCESSIBLE PATH OF TRAVEL AS INDICATED ON PLAN IS A BARRIER-FREE ACCESS ROUTE WITHOUT ANY ABRUPT LEVEL CHANGES THAT WILL BE GREATER THEN 1/2" WHEN CHANGES TO OCCUR, THEY SHALL BE BEVELED WITH A MAX. SLOPE OF 1:2. LEVEL CHANGES LESS THAN A 1/4" MAX MAY BE VERTICAL, AND AT LEAST 48" IN WIDTH. SURFACE IS STABLE, FIRM, AND SLIP RESISTANT. THE MAXIMUM PERMITTED CROSS SLOPE SHALL NOT EXCEED 1:48, AND SLOPE IN THE DIRECTION OF TRAVEL IS LESS THAN 5%, IF GREATER THAN 5% THEY MUST COMPLY RAMP REQUIREMENTS PER SECTION 11B-402.2. ACCESSIBLE PATH OF TRAVEL SHALL BE MAINTAINED FREE OF OVERHANGING OBSTRUCTIONS TO 80" MINIMUM, AND PROTRUDING OBJECTS GREATER THAN 4" PROJECTION FROM WALL AND ABOVE 27" AND LESS THAN 80". ARCHITECT SHALL VERIFY THAT THERE ARE NO BARRIERS IN THE PATH OF TRAVEL.

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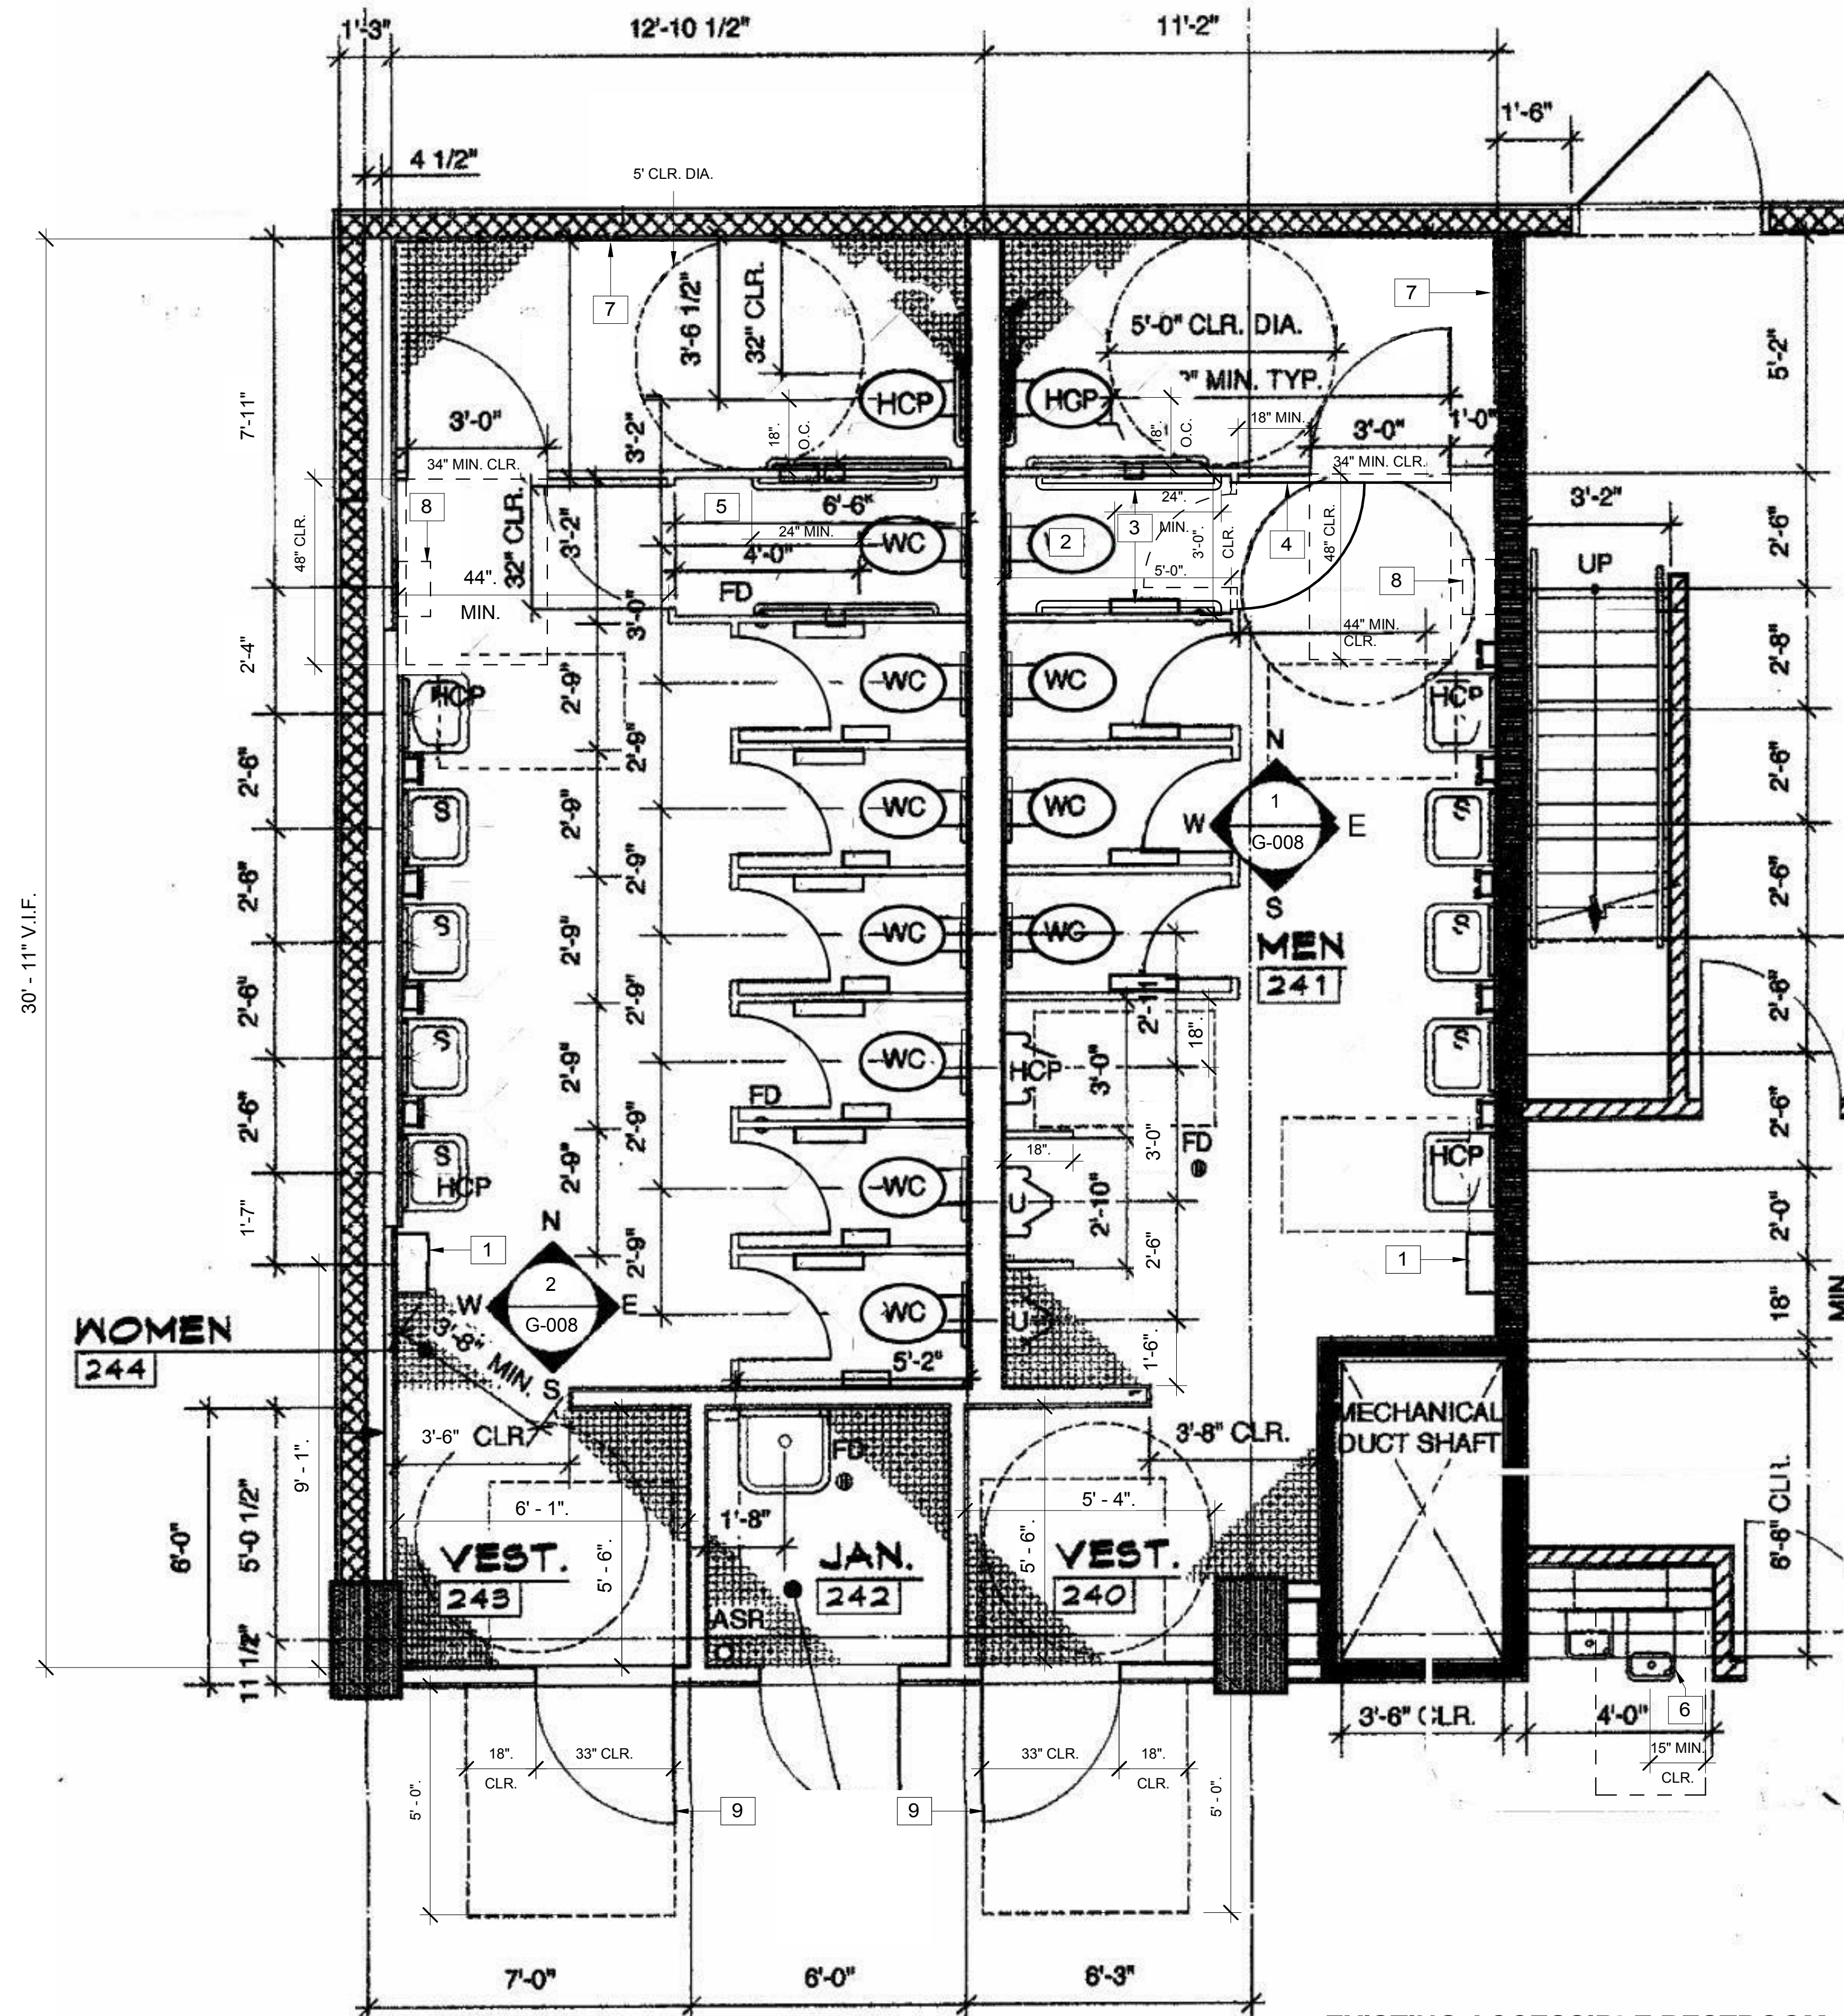
DATE: 10/06/17

SHEET TITLE

CS BUILDING ACCESSIBLE PARKING UPGRADE

SHEET NUMBER

G-006



EXISTING ACCESSIBLE RESTROOM 1
1" = 1'-0"

KEYNOTES

- 1 REPLACE EXISTING PAPER TOWEL DISPENSER WITH NEW 4" DEEP MAX. PAPER TOWEL DISPENSER BY BOBRICK MODEL: B-262
- 2 CONVERT EXISTING STALL TO AMBULATORY STALL
- 3 NEW 42" GRAB BAR, EA SIDE, SEE 4/A-800
- 4 NEW PARTITION DOOR PER SPECIFICATIONS
- 5 EXISTING AMBULATORY STALL TO REMAIN
- 6 EXISTING ACCESSIBLE DRINKING FOUNTAIN CONFORMS WITH ALL ACCESSIBLE CLEARANCE REQUIREMENTS AS SHOWN IN DETAIL 3/A-800
- 7 REMOVE EXISTING BABY CHANGING STATIONS FROM ACCESSIBLE STALL, AND REPAIR/PATCH WALL TO MATCH EXISTING WALL
- 8 REMOVE EXISTING PAPER TOWEL DISPENSER, REPAIR/PATCH WALL TO MATCH EXISTING WALL
- 9 ADJUST DOOR CLOSER SO THAT FORCE REQUIRED TO OPEN DOOR IS < 5 LBS.

CLIENT



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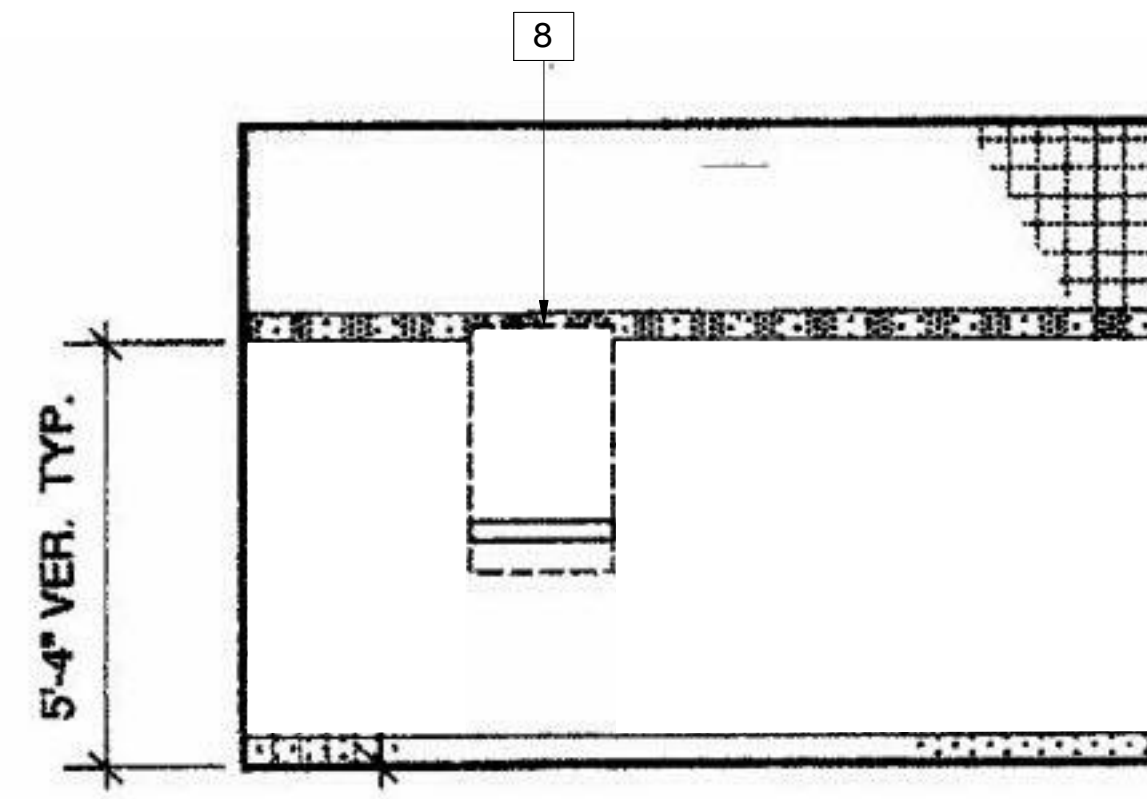
DATE 10/06/17

SHEET TITLE


EXISTING ACCESSIBLE RESTROOMS

SHEET NUMBER


G-007




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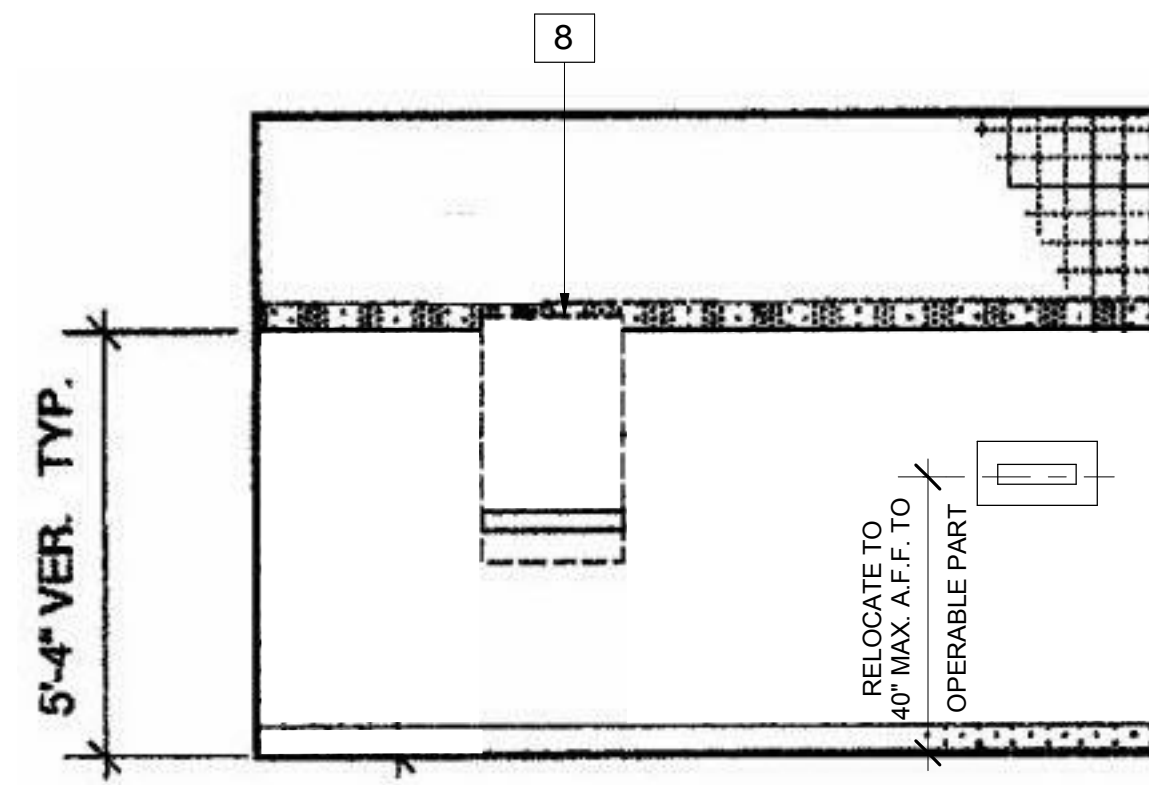

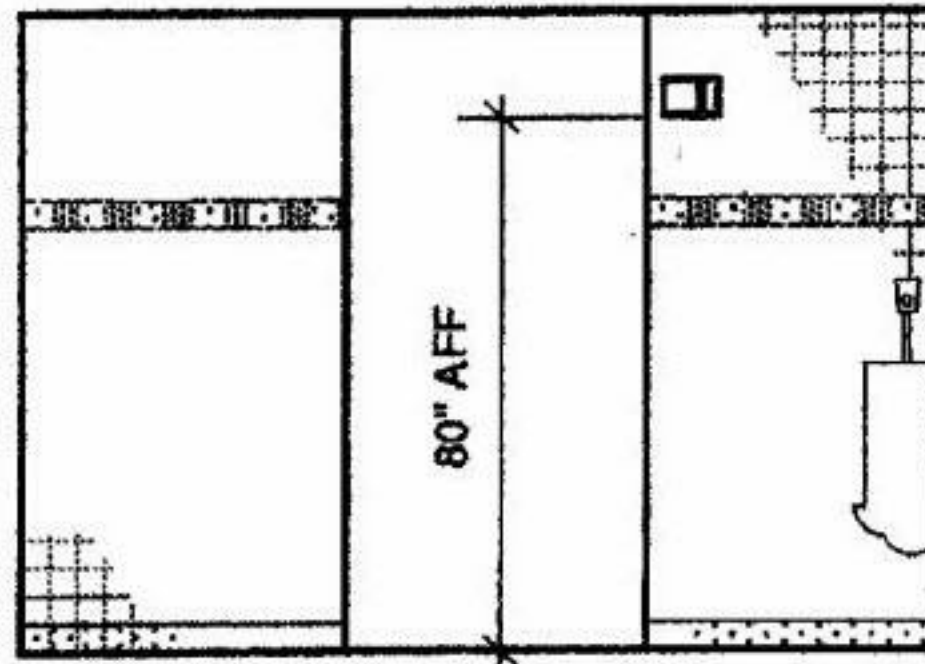
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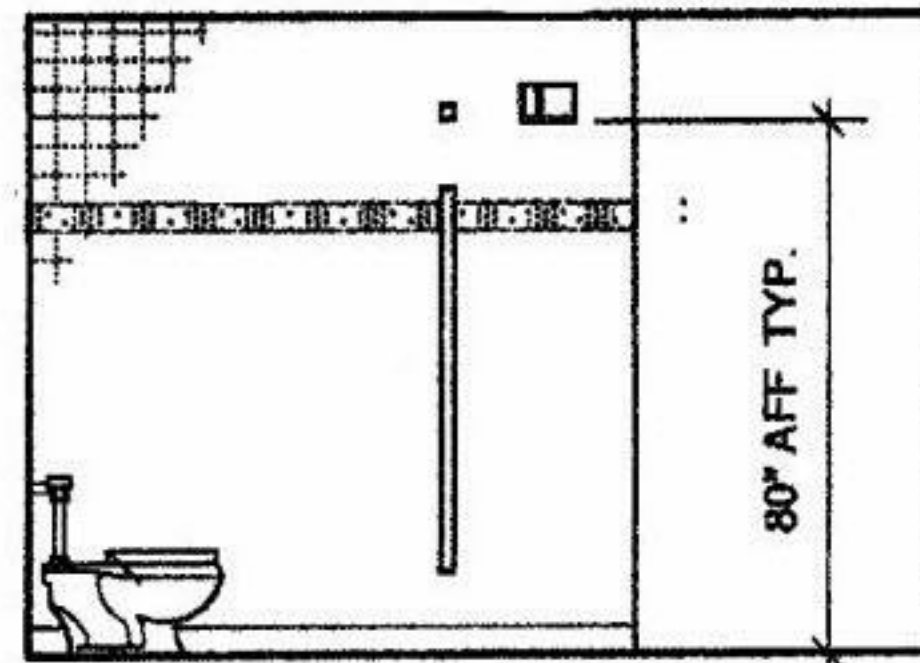
FLUSH VALVE @ WIDE SIDE, TYPICAL

INTERIOR ELEVATION MEN'S RESTROOM

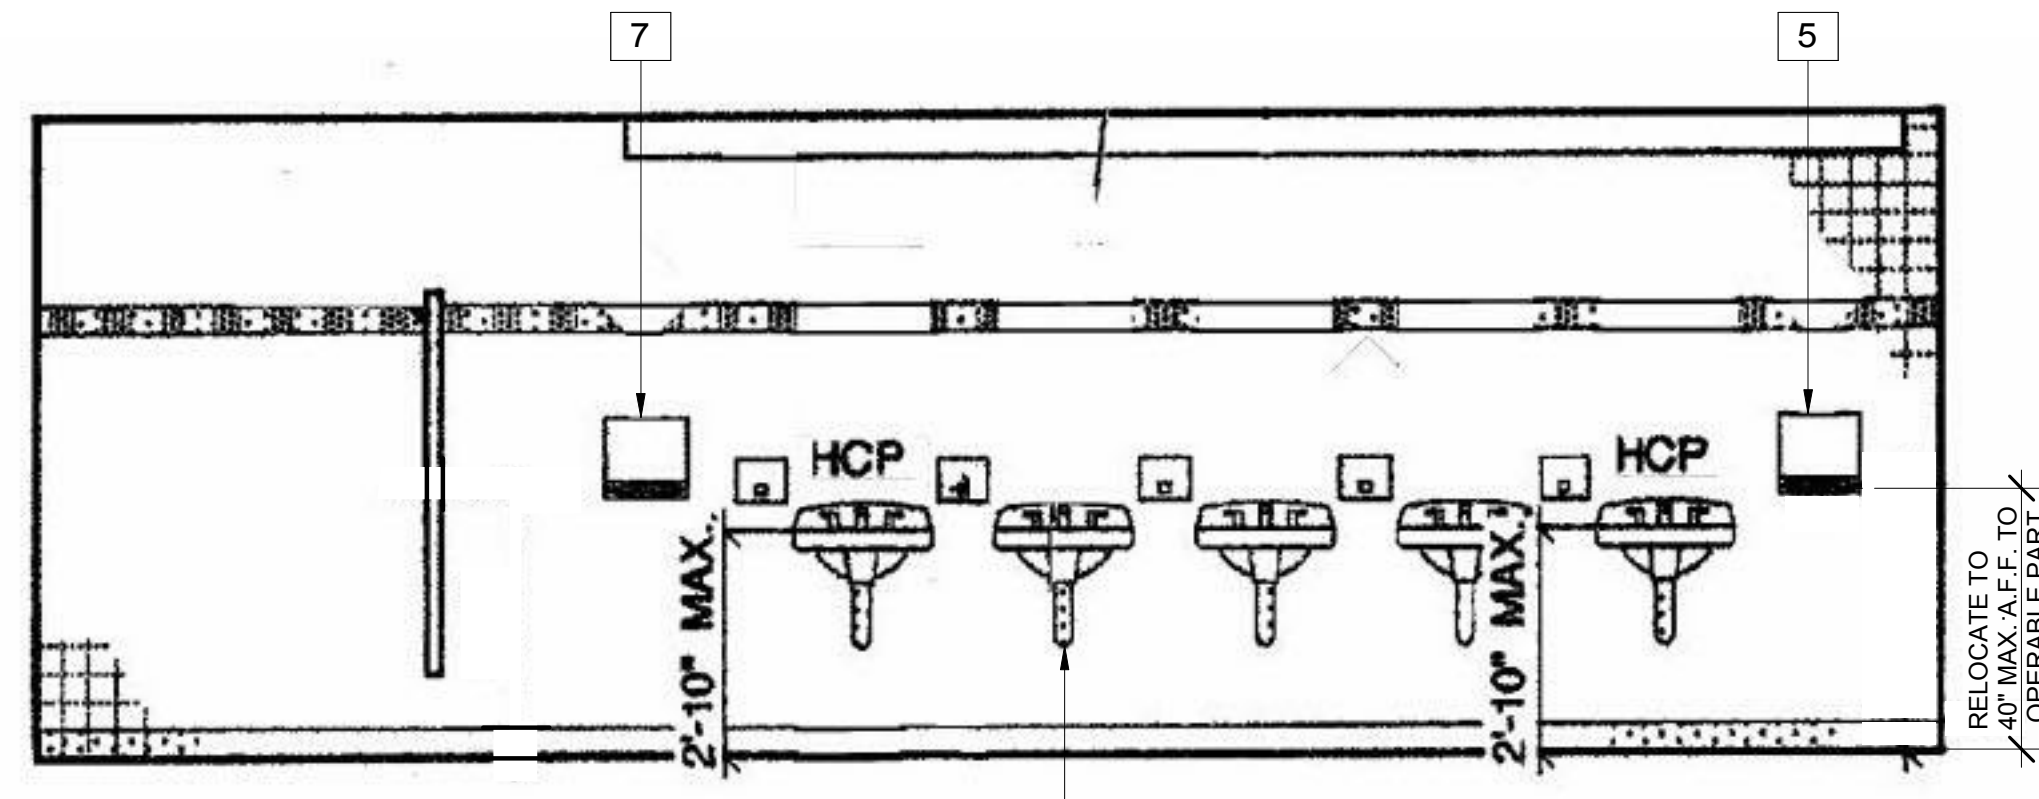
NTS 1

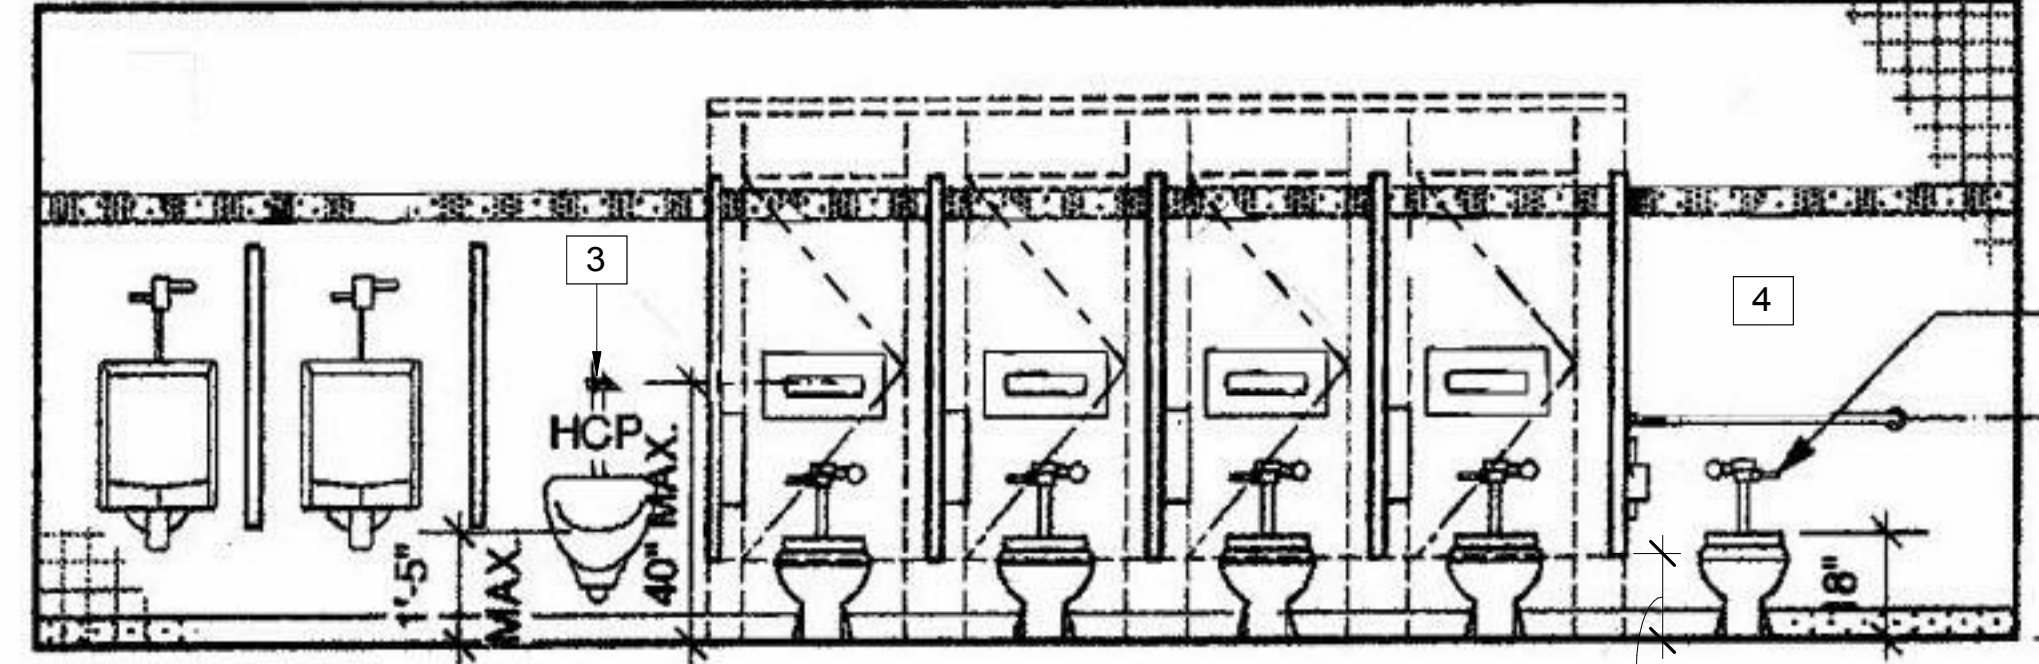


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U



N

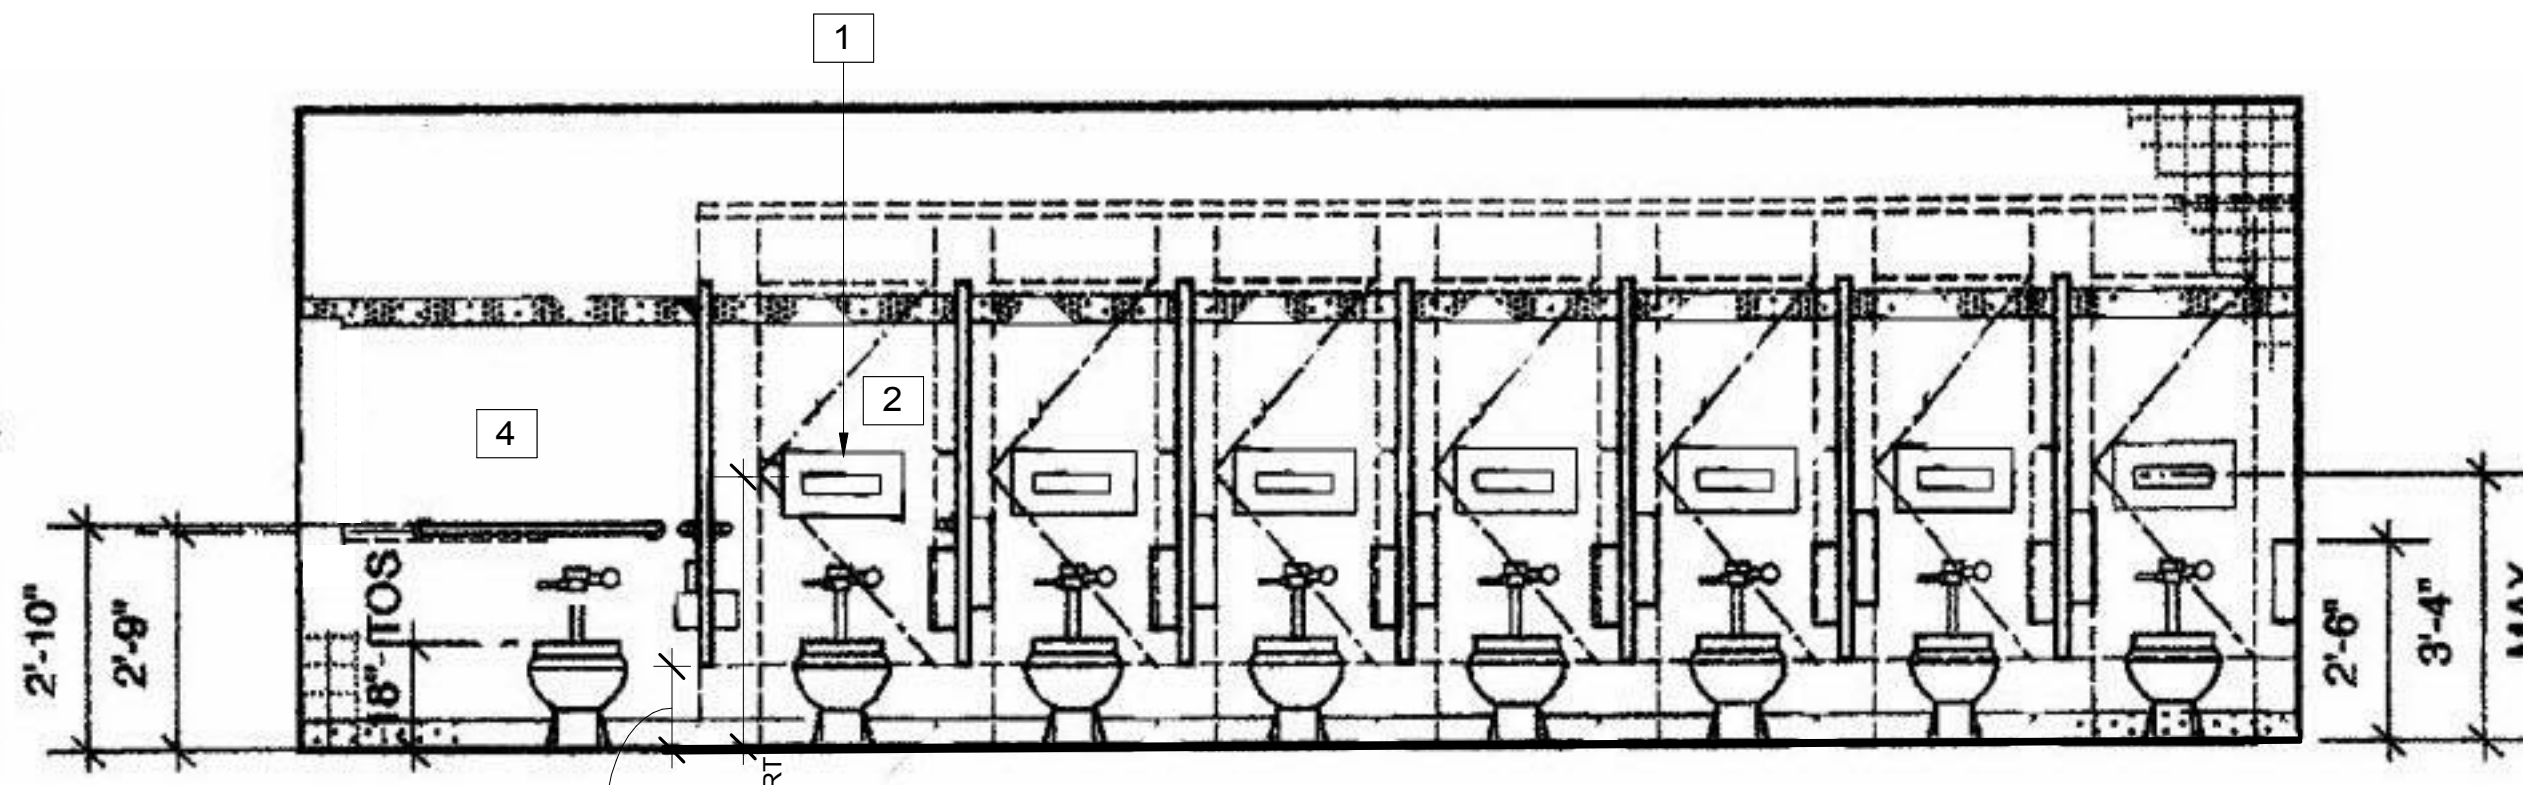

M

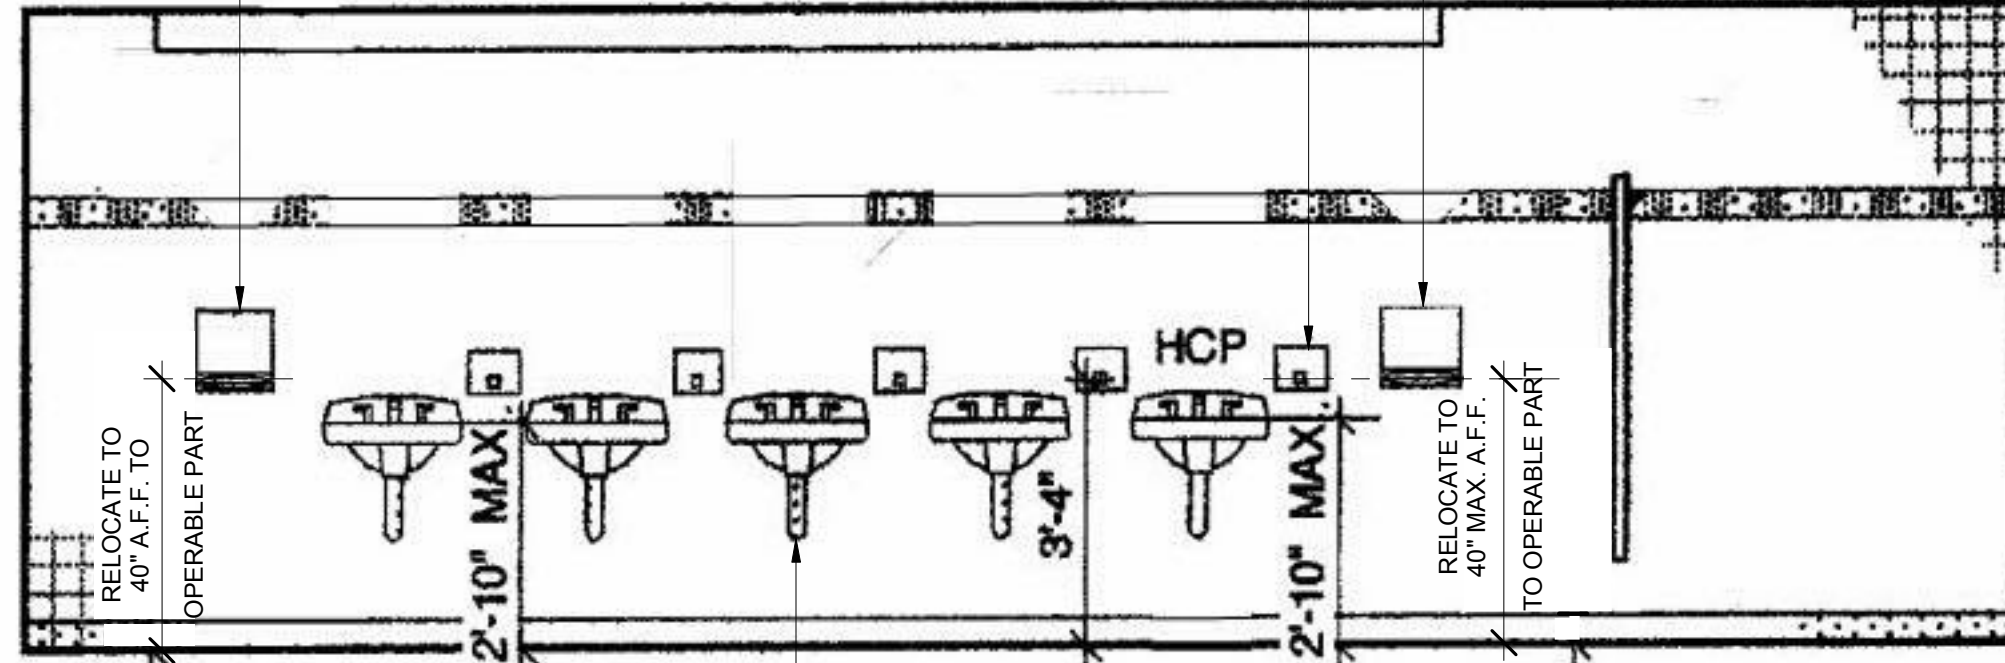INTERIOR ELEVATIONS WOMEN'S RESTROOM

NTS 2

KEYNOTES

- 1 RELOCATE EXISTING SEAT COVER DISPENSER
- 2 EXISTING AMBULATORY STALL
- 3 EXISTING ACCESSIBLE URINAL
- 4 EXISTING ACCESSIBLE STALL, CLEARANCES PER 41A-800
- 5 REPLACE EXISTING PAPER TOWEL DISPENSER WITH NEW 4" DEEP MAX. PAPER TOWEL DISPENSER BY BOBRICK MODEL: B-262. REPAIR/PATCH WALL TO MATCH EXISTING AS NEEDED.
- 6 RELOCATE EXISTING SOAP DISPENSER, REPAIR/PATCH WALL TO MATCH EXISTING AS NEEDED
- 7 REMOVE EXISTING TOWEL DISPENSER AND REPAIR/PATCH WALL TO MATCH EXISTING WALL
- 8 REMOVE EXISTING DIAPER CHANGING STATION, REPAIR/PATCH WALL TO MATCH EXISTING WALL
- 9 ALL WATER PIPES AND DRAIN PIPES SHALL BE INSULATED, WITH NO SHARP EDGES

CLIENT

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SCALE: As indicated

DESIGN ITERATION 10/06/17

DSA Submittal 10/06/2017

DATE 10/06/17

SHEET TITLE

EXISTING
INTERIOR
RESTROOM
ELEVATIONS

SHEET NUMBER

G-008

CLIENT



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DESIGNER



CONSULTANTS

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SCALE: 1/4" = 1'-0"

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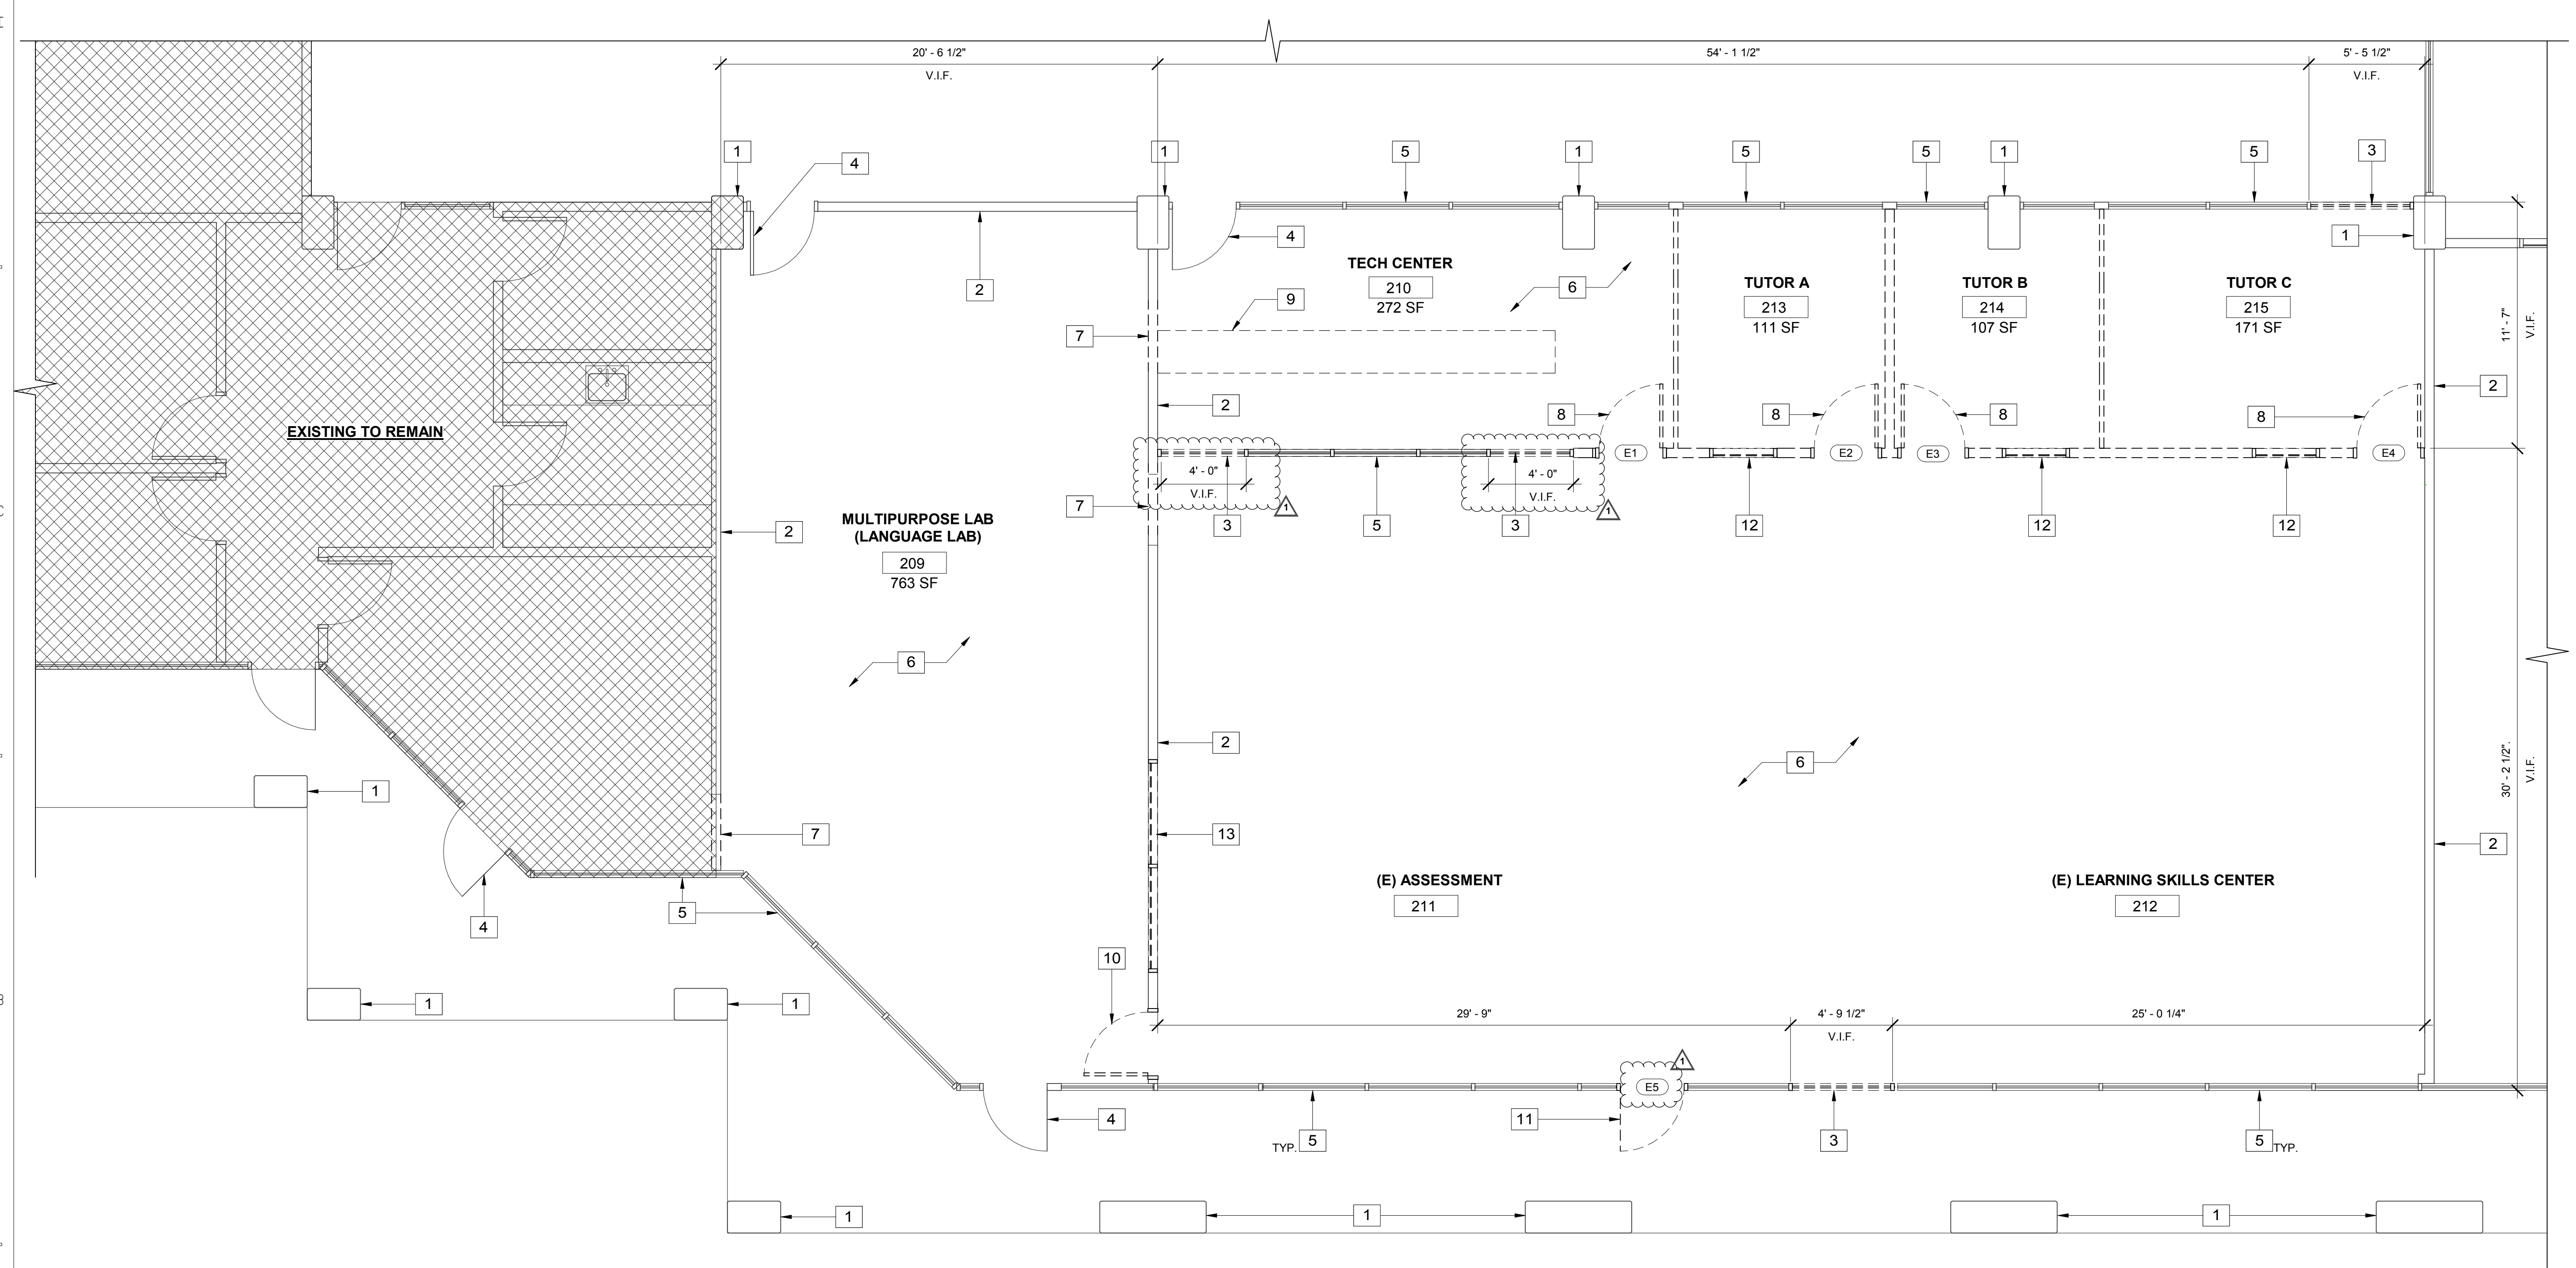
DATE 10/06/17

SHEET TITLE

DEMO FLOOR PLAN

SHEET NUMBER

A-200



DEMO PLAN 1
1/4" = 1'-0"

KEYNOTES

- 1 EXISTING COLUMN TO REMAIN
- 2 EXISTING WALL TO REMAIN
- 3 PORTION OF EXISTING STOREFRONT TO BE REMOVED FOR NEW DOOR
- 4 EXISTING DOOR TO REMAIN
- 5 EXISTING STOREFRONT TO REMAIN
- 6 EXISTING FLOOR FINISH TO REMAIN - U.N.O.
- 7 PORTION OF EXISTING WALL TO BE REMOVED FOR NEW DOOR
- 8 RELOCATE EXISTING DOOR TO NEW LOCATION PER A-201 - U.N.O.
- 9 REMOVE EXISTING CASEWORK
- 10 REMOVE EXISTING DOOR
- 11 RELOCATE EXISTING DOOR TO NEW LOCATION -INFILL EXISTING STOREFRONT DOOR OPENING WITH STOREFRONT GLAZING TO MATCH ADJACENT
- 12 RELOCATE EXISTING WINDOWS TO NEW LOCATON PER A-201
- 13 REMOVE EXISTING WINDOW

DEMO LEGEND

- EXISTING WALL TO REMAIN
- EXISTING WALL TO BE DEMOLISHED
- EXISTING TO REMAIN, N.I.C.



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▲	3/24/2018	ADDENDUM 2

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CHECKED BY: Checker

SCALE: 1/4" = 1'-0"

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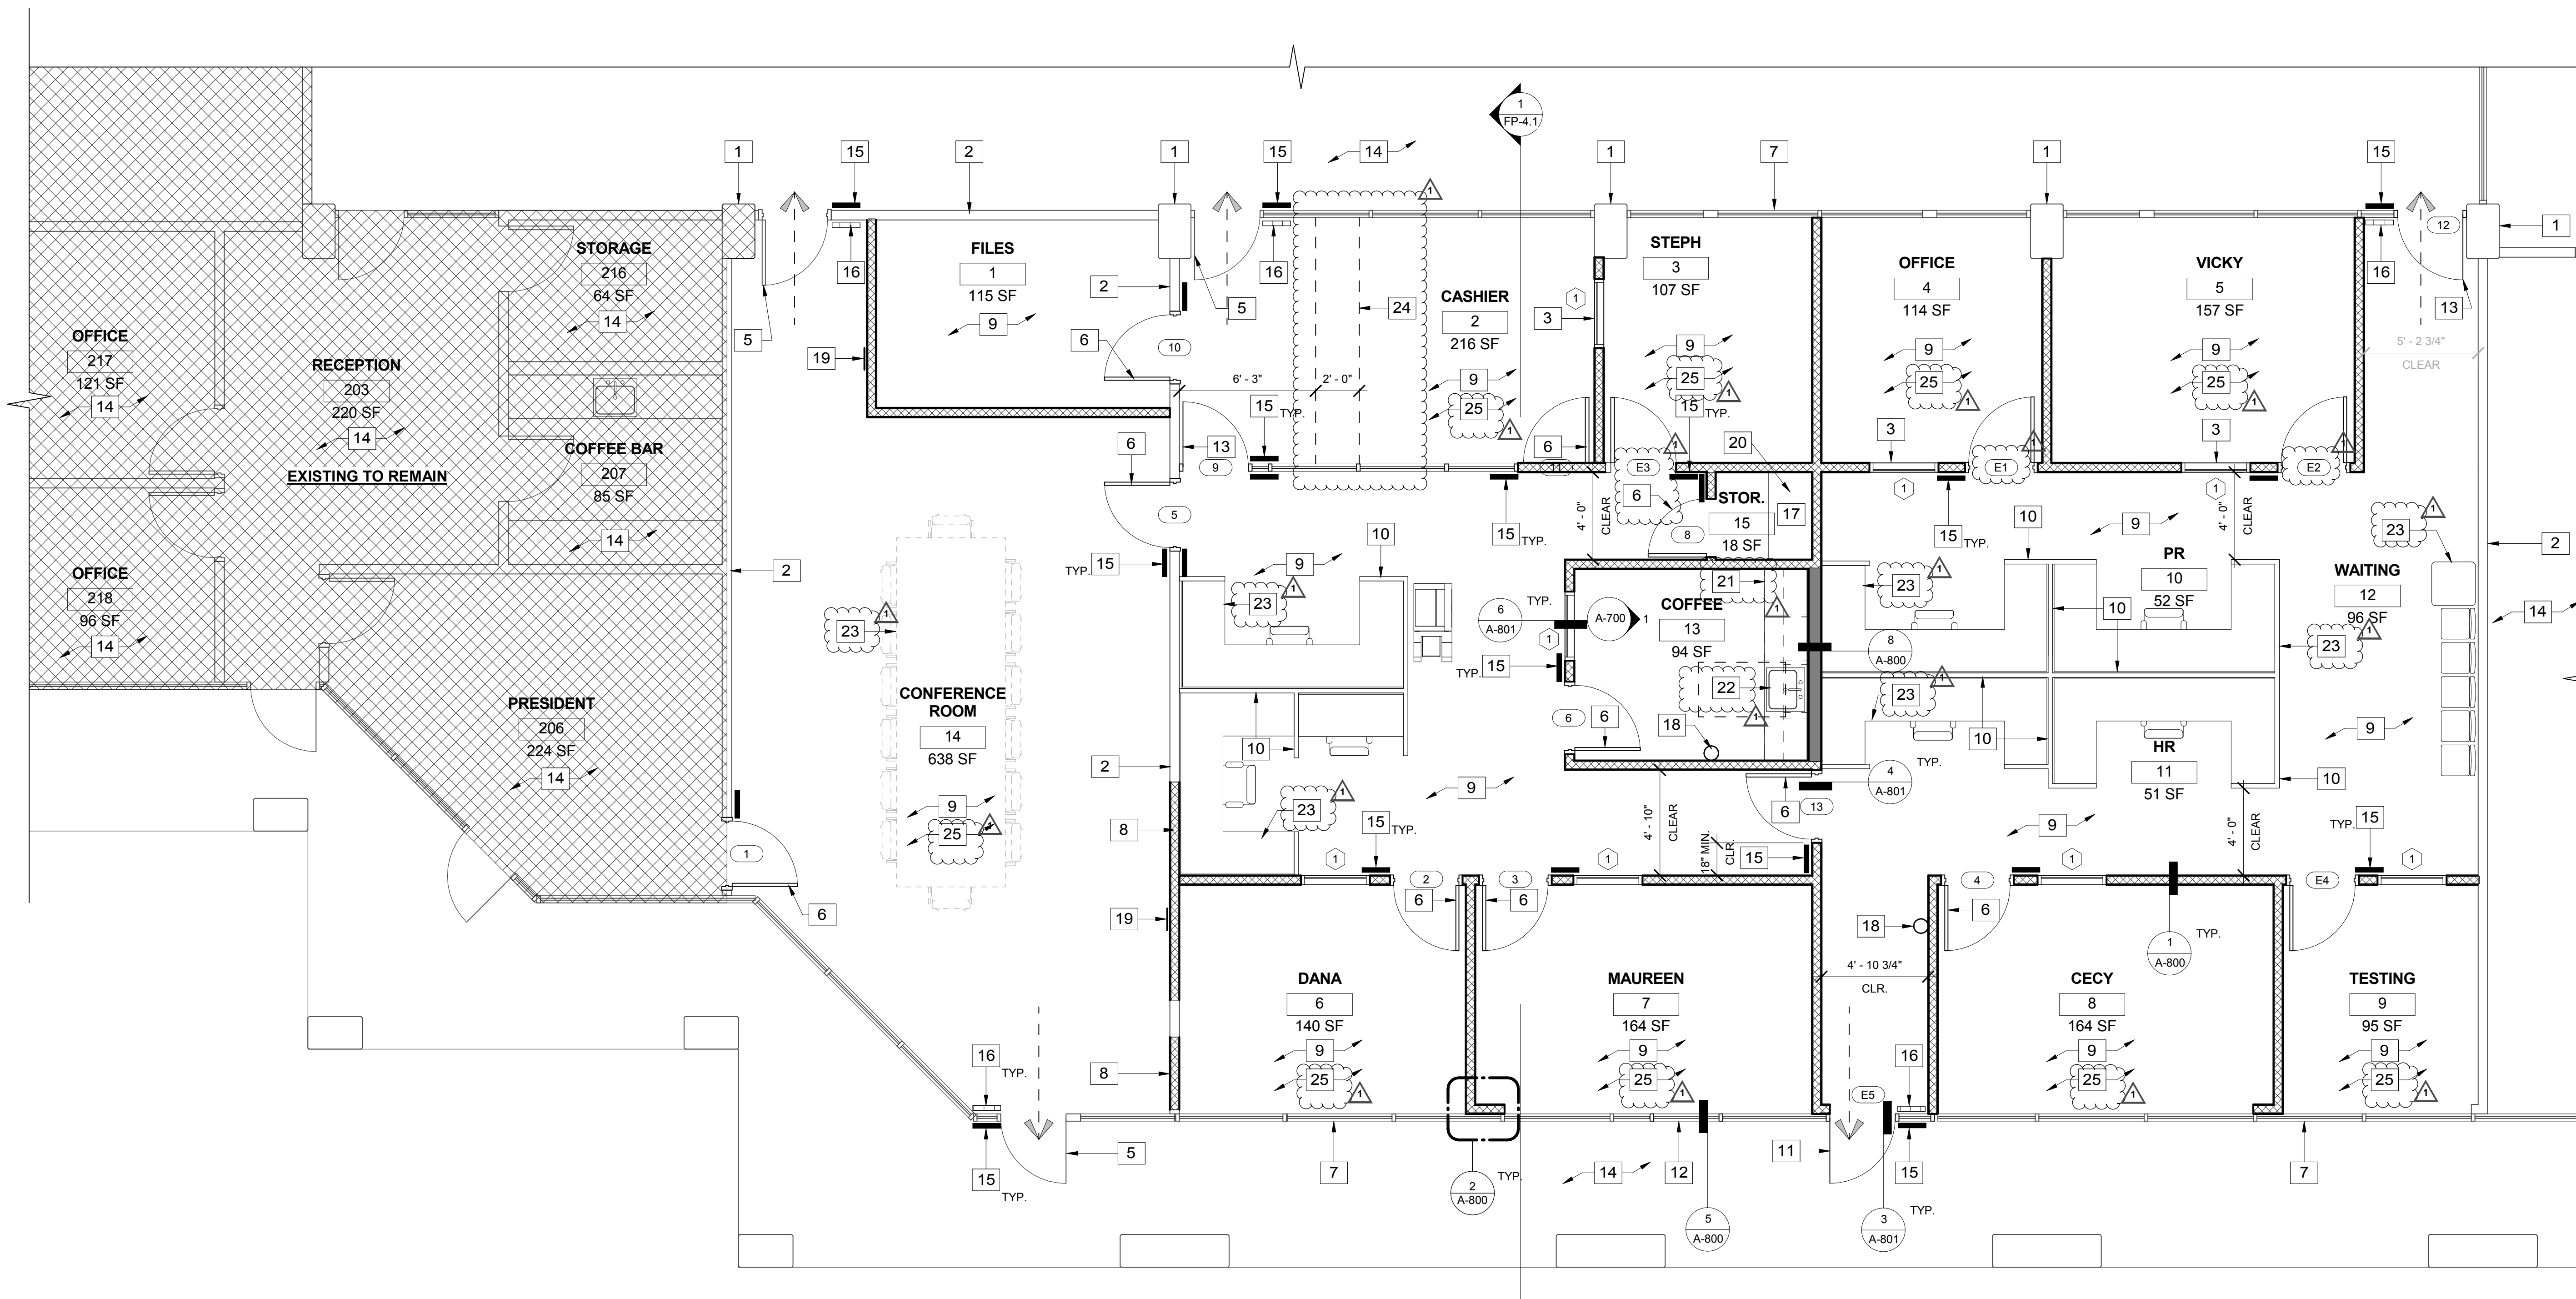
DATE 10/06/17

SHEET TITLE


PROPOSED FLOOR PLAN

SHEET NUMBER

A-201



PROPOSED FLOOR PLAN 1
1/4" = 1'-0"

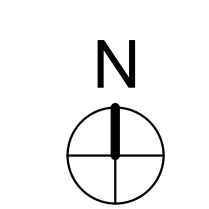


KEYNOTES

- | | |
|---|--|
| 1 EXISTING COLUMN TO REMAIN | 12 INFILL STOREFRONT GLAZING AT (E) DOOR LOCATION TO MATCH ADJACENT, PER 5/A-800 |
| 2 EXISTING WALL TO REMAIN | 13 NEW STOREFRONT DOOR TO MATCH EXISTING STOREFRONT PER SCHEDULE |
| 3 NEW LOCATION OF RELOCATED OFFICE WINDOW | 14 NOT IN CONTRACT |
| 4 NOT USED | 15 NEW TACTILE ROOM I.D. SIGN, SEE 4/A-802 |
| 5 EXISTING DOOR TO REMAIN | 16 NEW EXIT SIGNAGE, SEE 3/A-802 |
| 6 NEW DOOR PER SCHEDULE | 17 NEW 24"-DEEP SHELVING IN STORAGE CABINET |
| 7 EXISTING STOREFRONT TO REMAIN | 18 NEW FIRE EXTINGUISHER |
| 8 INFILL WALL TO MATCH EXISTING ADJACENT | 19 PROVIDE ASSITIVE-LISTENING DEVICE SIGNAGE PER DETAIL 6/A-802 |
| 9 EXISTING FLOOR FINISH TO REMAIN, PATCH AND REPAIR AS NECESSARY. RESILIENT BASE PROVIDED BY OWNER AFTER CONSTRUCTION. N.I.C. | 20 PORTABLE ASSITIVE-LISTENING DEVICE STORAGE LOCATION |
| 10 NEW PARTIAL HEIGHT CUBICLE PARTITION. PROVIDED AND INSTALLED BY PVC | |
| 11 NEW LOCATION OF RELOCATED STOREFRONT DOOR | |

LEGEND

- | | |
|--|---|
| | EXISTING WALL TO REMAIN |
| | NEW METAL STUD WALL WITH 5/8" GYP BD BOTH SIDES, SEE DETAIL 1/A-800 & STRUCTURAL PLANS |
| | NEW METAL STUD PLUMBING WALL WITH 5/8" GYP BD ON OUTSIDE FACE AND W.P. GREEN BOARD IN THE INSIDE/PLUMBING FACE, SEE DETAIL 8/A-800 & STRUCTURAL PLANS |
| | EGRESS PATH OF TRAVEL |
| | EXISTING TO REMAIN, N.I.C. |
| | NEW TACTILE ROOM I.D. PER 4/A-802 |
| | NEW EXIT SIGNAGE PER 3/A-802 |
| | 21 NEW PLASTIC-LAMINATE CASEWORK PER SPECIFICATIONS |
| | 22 NEW SINK PER PLUMBING PLANS |
| | 23 NEW FURNITURE PROVIDED BY PVC, N.I.C. |
| | 24 RECEPTIONIST COUNTER WITH UNDER CABINETS PROVIDED BY PVC, N.I.C. |
| | 25 PROVIDE NEW BATT INSULATION ABOVE, PER 1/A-800 |

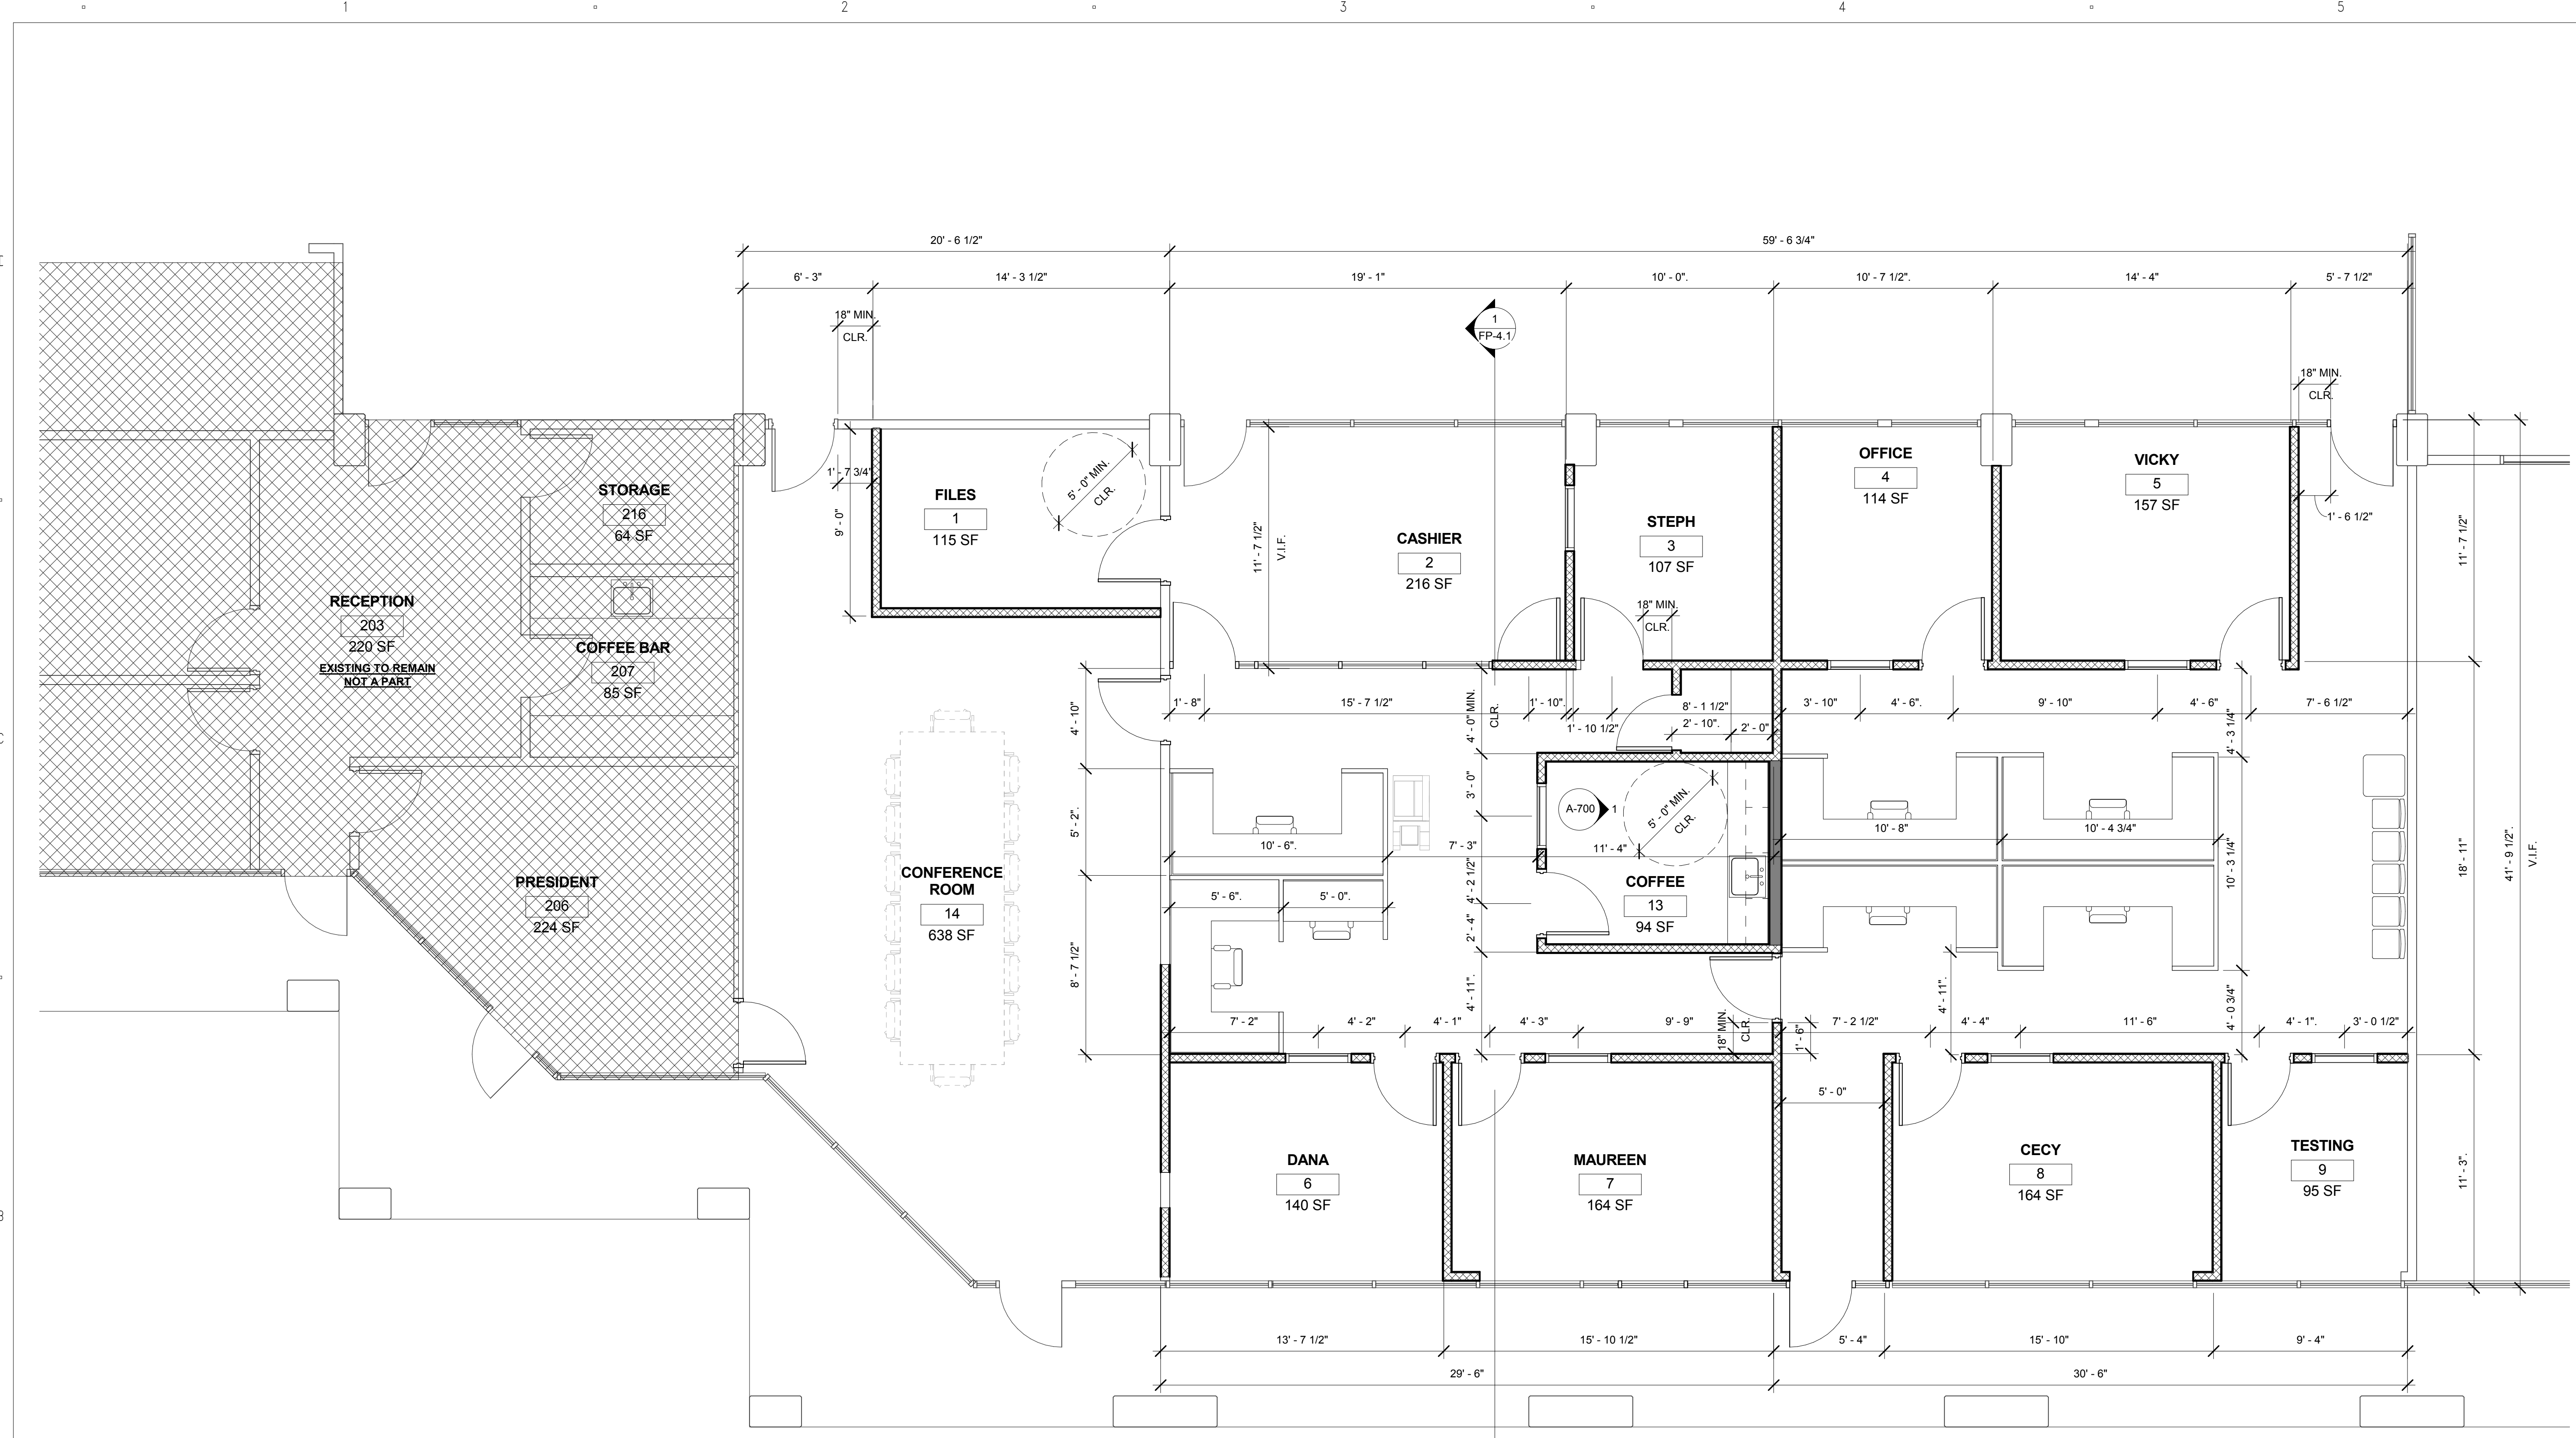

PROPOSED FLOOR PLAN -DIMENSIONS ①
1/4" = 1'-0"

LEGEND

- EXISTING WALL TO REMAIN
- NEW METAL STUD WALL WITH 5/8" GYP BD BOTH SIDES. SEE DETAIL 1/A-800 & STRUCTURAL PLANS
- NEW METAL STUD PLUMBING WALL WITH 5/8" GYP BD ON OUTSIDE FACE AND W.P. GREEN BOARD IN THE INSIDE/PLUMBING FACE. SEE DETAIL 8/A-800 & STRUCTURAL PLANS
- EGRESS PATH OF TRAVEL
- EXISTING TO REMAIN, N.I.C.
- NEW TACTILE ROOM I.D. PER 4/A-802
- NEW EXIT SIGNAGE PER 3/A-802

CLIENT

PALO VERDE COLLEGE
WHERE KNOWLEDGE TAKES ROOT AND OPPORTUNITY GROWS

Palo Verde Community College District
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Blythe, CA 92225

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College Services Building
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CONTRACTOR

DESIGNER

SILLMAN WRIGHT ARCHITECTS 31045 Temecula Parkway Suite 204
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CONSULTANTS

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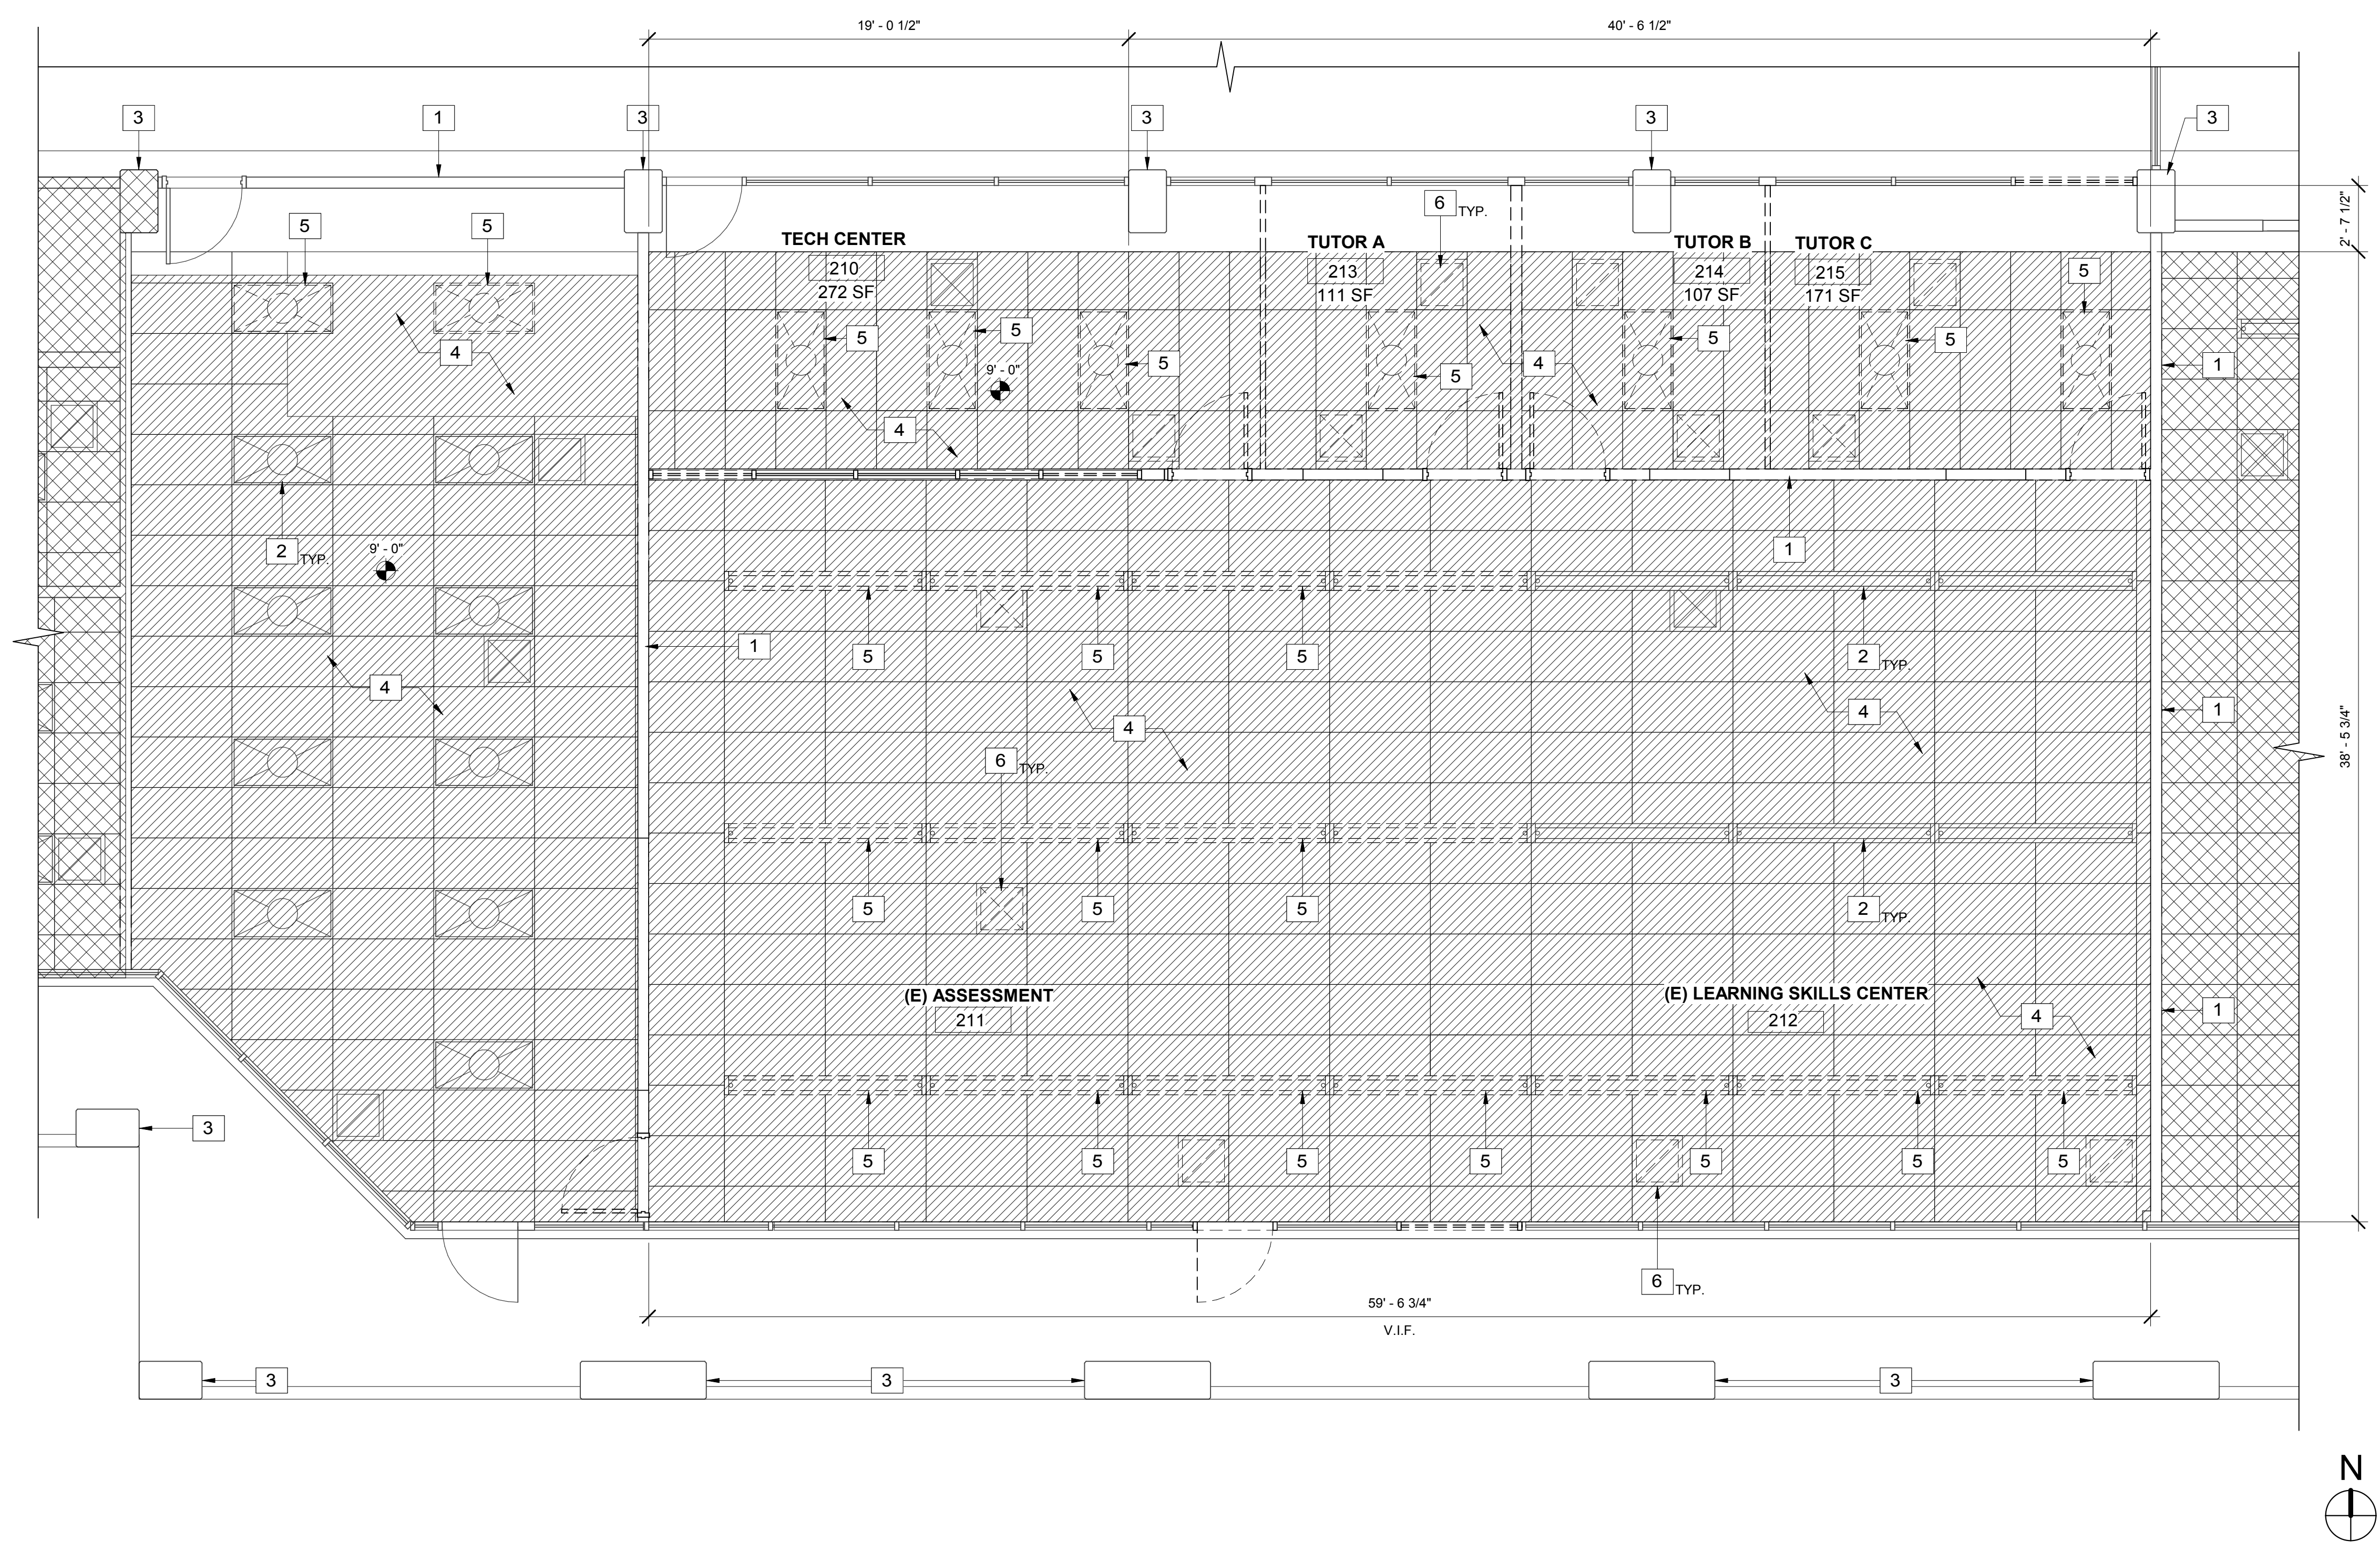
DATE 10/06/17

SHEET TITLE

PROPOSED FLOOR PLAN -DIMENSIONS

SHEET NUMBER

A-201.1



DEMOLITION CEILING PLAN 1
1/4" = 1'-0"

KEYNOTES		LEGEND	
1	EXISTING WALL TO REMAIN, TYP.		EXISTING WALL TO REMAIN
2	EXISTING LIGHT FIXTURES TO REMAIN, U.N.O.		EXISTING PORTION OF CEILING TO BE REMOVED.
3	EXISTING COLUMNS TO REMAIN		EXISTING CEILING TO REMAIN
4	EXISTING PORTION OF CEILING TO BE REMOVED.		EXISTING TO REMAIN 2X4 LIGHT FIXTURE
5	EXISTING LIGHT TO BE REMOVED. REFER TO PROPOSED CEILING PLAN FOR NEW LOCATION IF APPLICABLE - RELINQUISH EXCESS TO PVCC.		EXISTING TO REMAIN 2X2 LIGHT FIXTURE
6	EXISTING MECHANICAL REGISTER TO BE REMOVED. REFER TO MECHANICAL PLANS FOR NEW LOCATIONS		EXISTING PENDANT LIGHT FIXTURE - REFER TO 7/A-804 & 15/S2.0 FOR BRACING INFO

CLIENT

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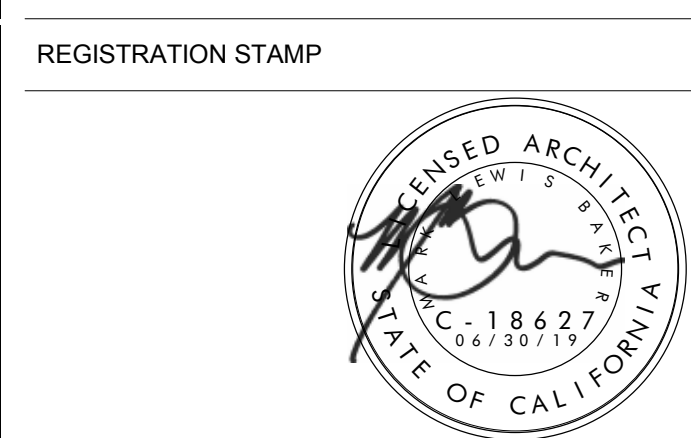
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DEMO CEILING PLAN


SHEET NUMBER

A-202

DOOR SCHEDULE							
Mark	Width	Height	Finish	Frame Material	Elevation	H.W. Group	Remarks - (ALL EXISTING DOORS & HARDWARE PER A04-10074)
1	3' - 0"	7' - 0"	SC	HM	A	01	
2	3' - 0"	7' - 0"	SC	HM	A	X05	
3	3' - 0"	7' - 0"	SC	HM	A	02	
4	3' - 0"	7' - 0"	SC	HM	A	02	
5	3' - 0"	7' - 0"	SC	HM	A	05	
6	3' - 0"	7' - 0"	SC	HM	A	03	
8	2' - 8"	7' - 0"	SC	HM	C	02	
9	3' - 0"	6' - 11"	ALUM SF	ALUM SF	B	06	
10	3' - 0"	7' - 0"	SC	HM	A	04	
11	3' - 0"	7' - 0"	SC	HM	D	07	DUTCH DOOR
12	3' - 0"	6' - 11"	ALUM SF	ALUM SF	B	08	
13	3' - 0"	7' - 0"	SC	HM	A	05	
E1	3' - 0"	7' - 0"	SC	HM	A	09	EXISTING TO BE REUSED, SCHLAGE NEPTUNE LEVER HARDWARE
E2	3' - 0"	7' - 0"	SC	HM	A	09	EXISTING TO BE REUSED, SCHLAGE NEPTUNE LEVER HARDWARE
E3	3' - 0"	7' - 0"	SC	HM	A	09	EXISTING TO BE REUSED, SCHLAGE NEPTUNE LEVER HARDWARE
E4	3' - 0"	7' - 0"	SC	HM	A	09	EXISTING TO BE REUSED, SCHLAGE NEPTUNE LEVER HARDWARE
E5	2' - 11 31/32"	6' - 11"	ALUM SF	ALUM SF	B	09	EXISTING TO BE REUSED


WINDOW SCHEDULE							
Mark	Width	Height	Sill Height	Head Height	Elevation	Comments	
1	3' - 2"	4' - 2"	3' - 0"	7' - 2"	A	INOPERABLE HOLLOW METAL, TO MATCH EXISTING	

LEGEND:
 SC SOLID CORE
 ALUM ALUMINUM
 HM HOLLOW METAL

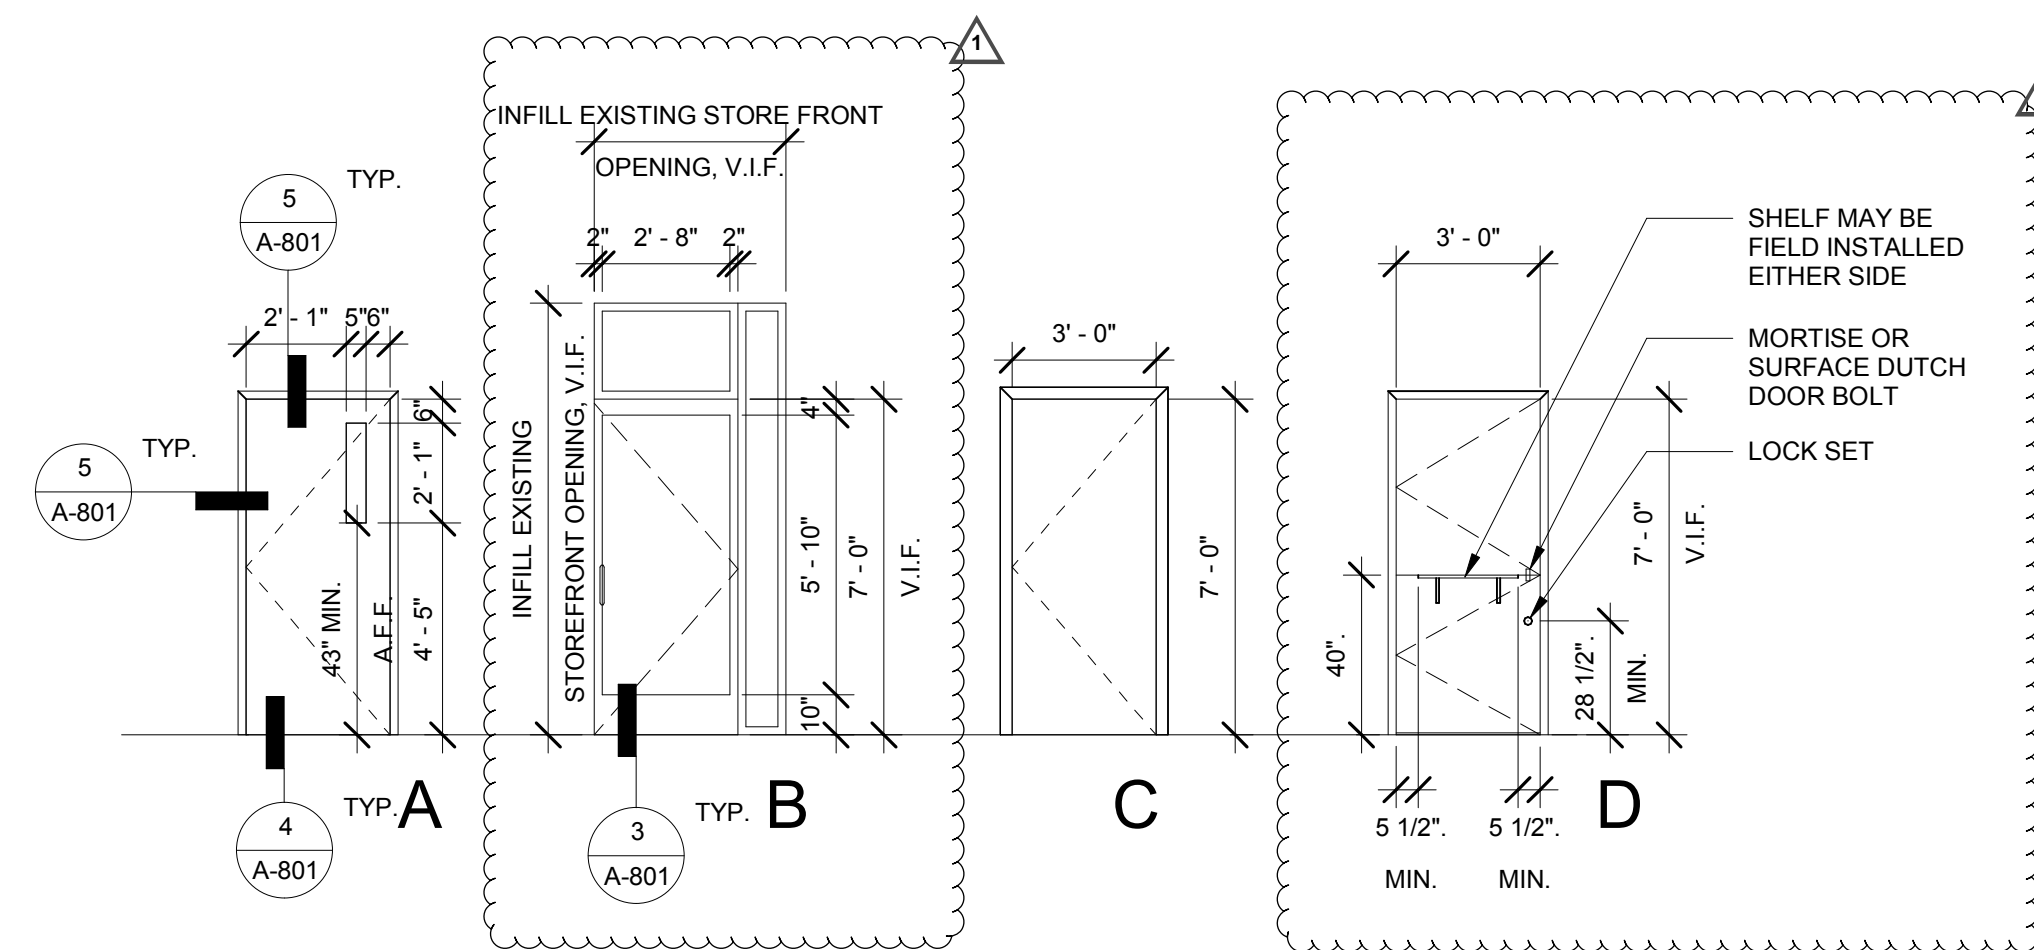


DOOR ELEVATIONS

1/4" = 1'-0"

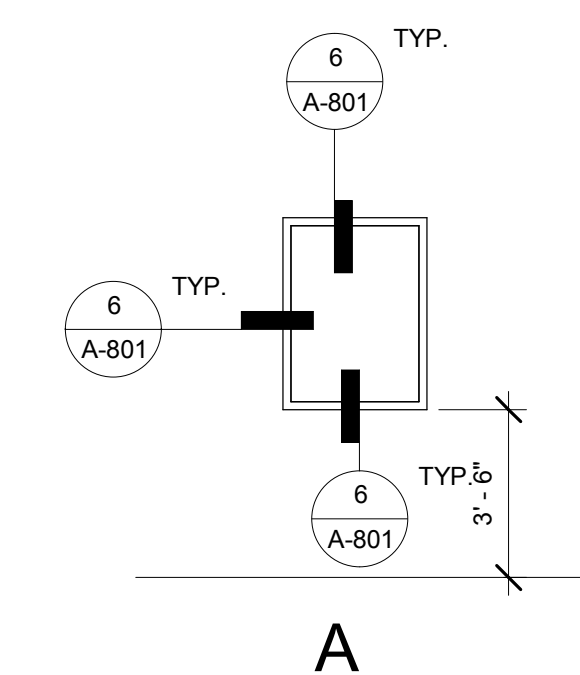

WINDOW ELEVATIONS

1/4" = 1'-0"

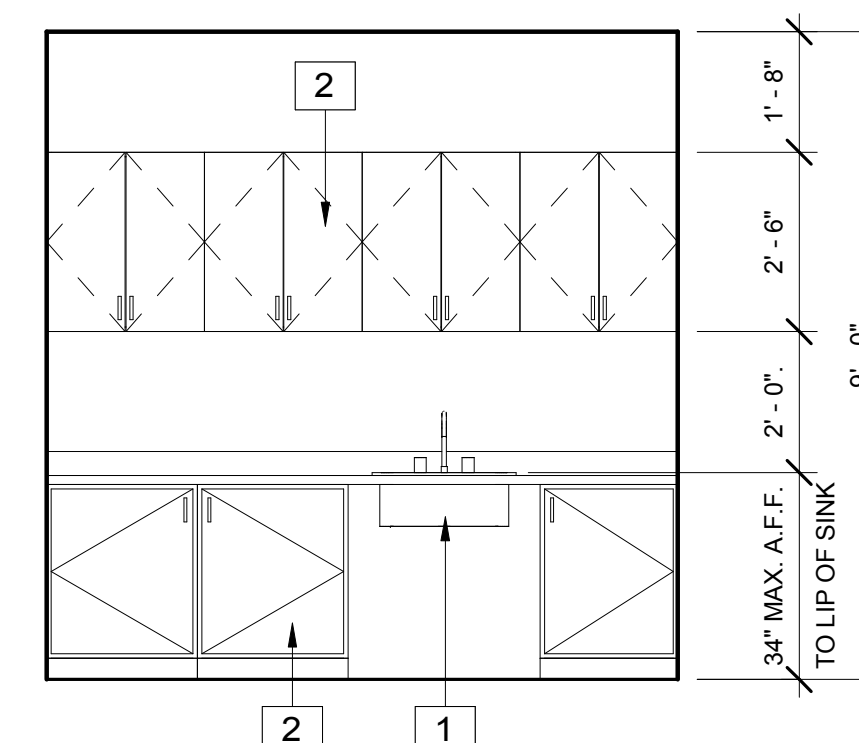

INTERIOR ELEVATION OF COFFEE ROOM

3/8" = 1'-0"

KEYNOTES

- 1 ACCESSIBLE SINK
- 2 PLASTIC LAMINATE FACED CABINET AND COUNTERTOP PER SPECIFICATIONS. PROVIDE SHOP DRAWINGS FOR REVIEW AND APPROVAL PRIOR TO FABRICATION. SEE 10/S2.0 FOR STRUCTURAL CONNECTION.

CLIENT



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DESIGN ITERATION 10/06/17

DSA Submittal 10/06/2017


DATE 10/06/17

SHEET TITLE


**SCHEDULES &
 INTERIOR
 ELEVATIONS**

SHEET NUMBER



A-700

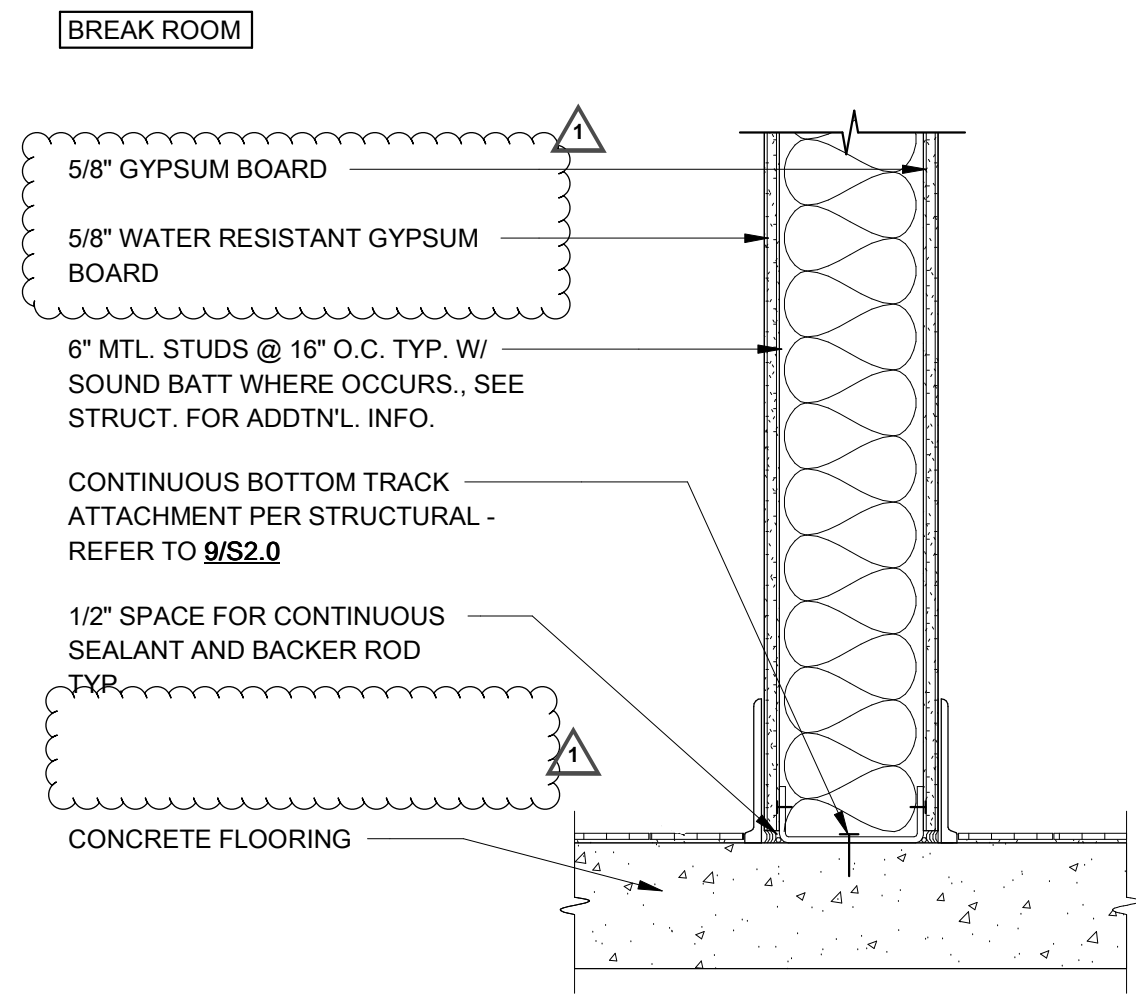


PLUMBING WALL 8
1 1/2" = 1'-0"

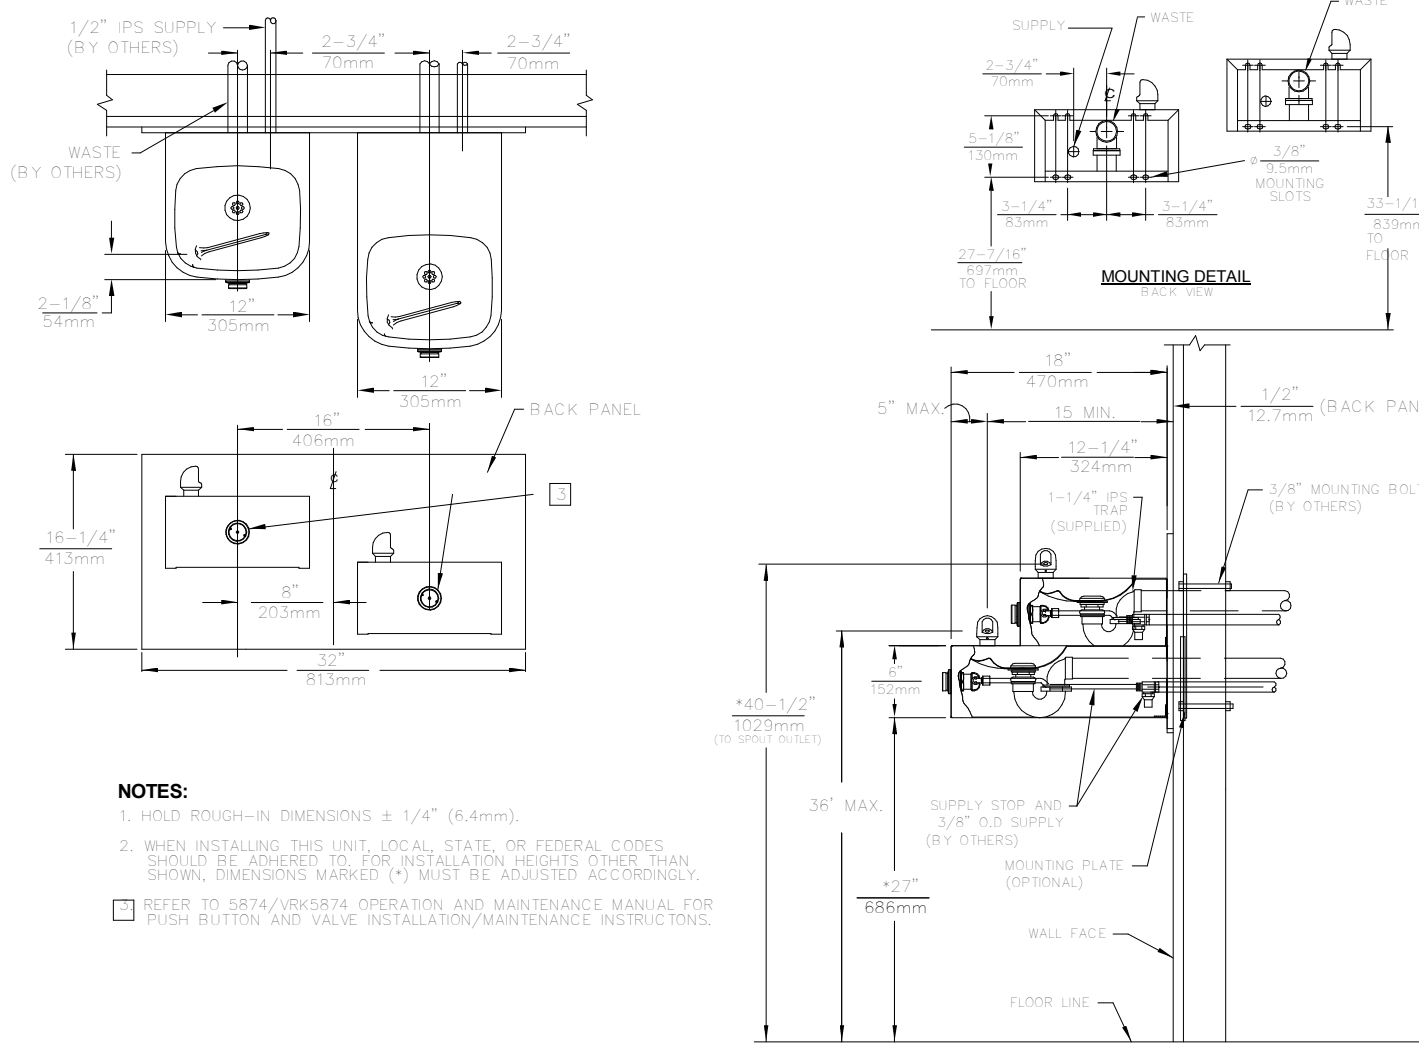


ACCESSIBLE DRINKING FOUNTAIN 3
3/4" = 1'-0"

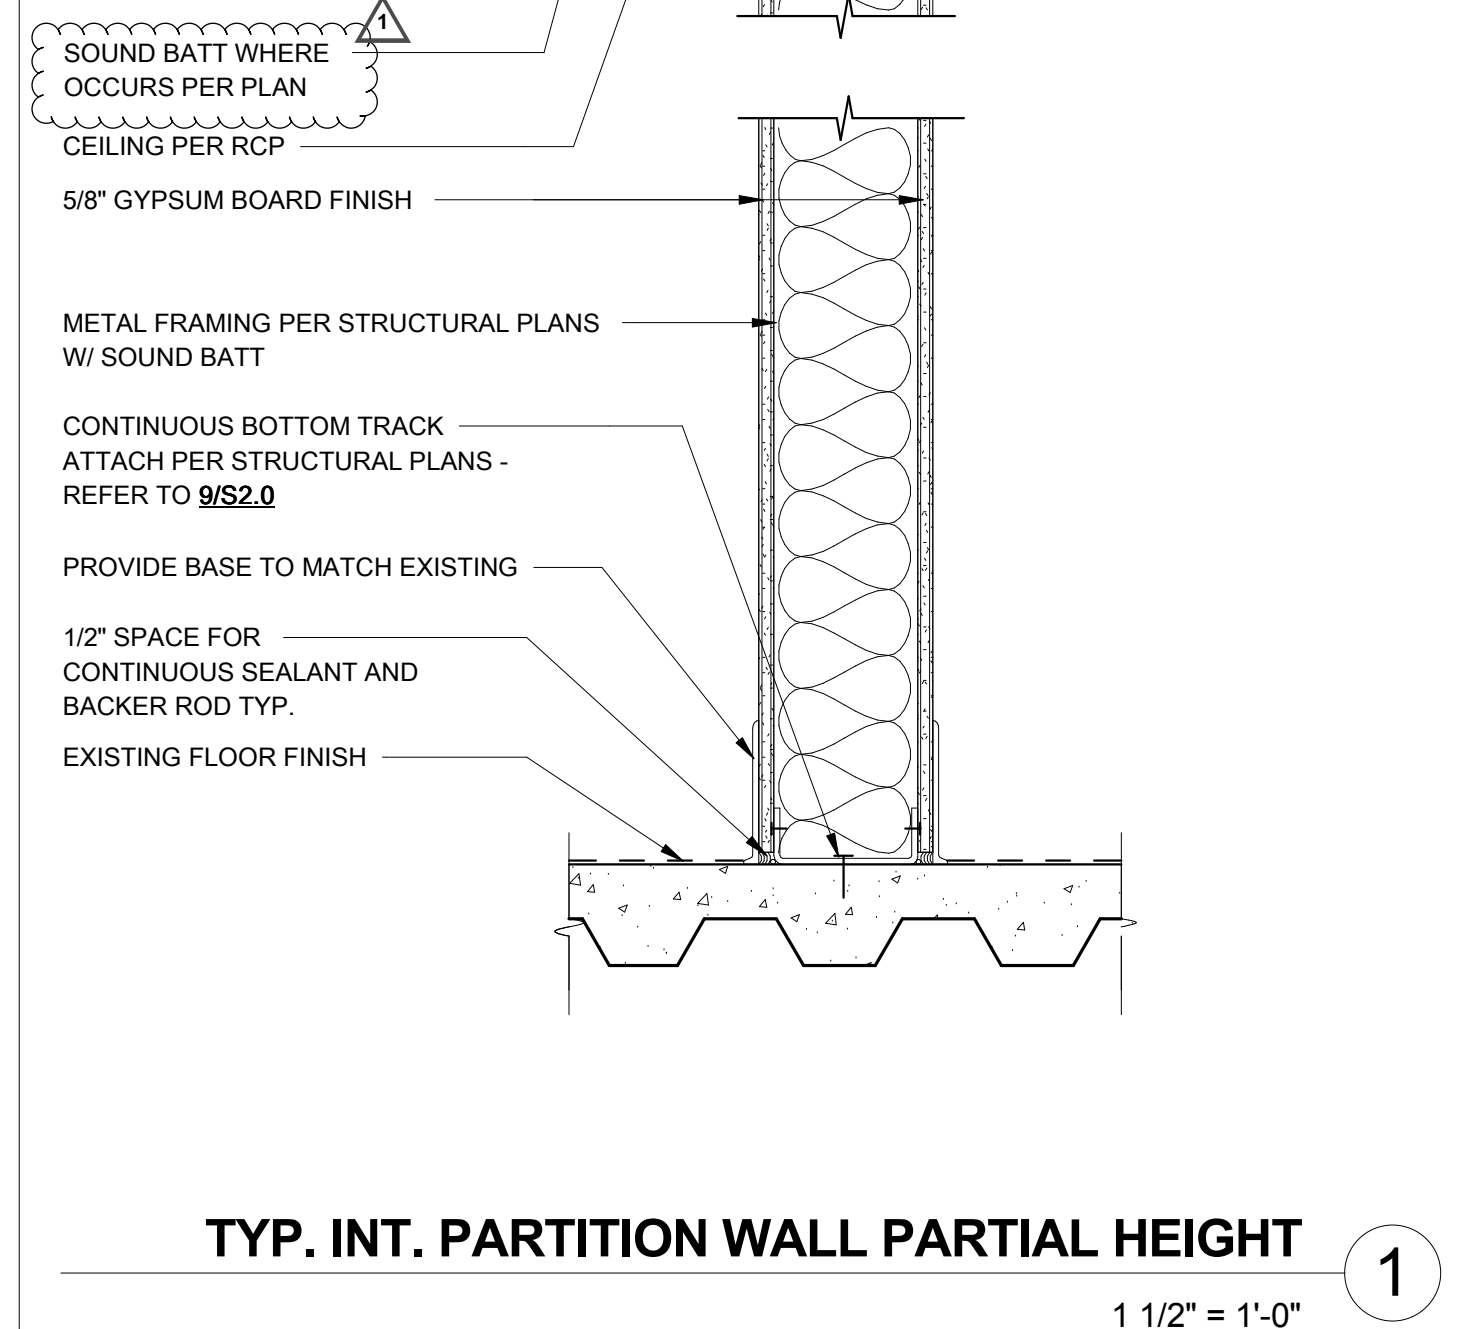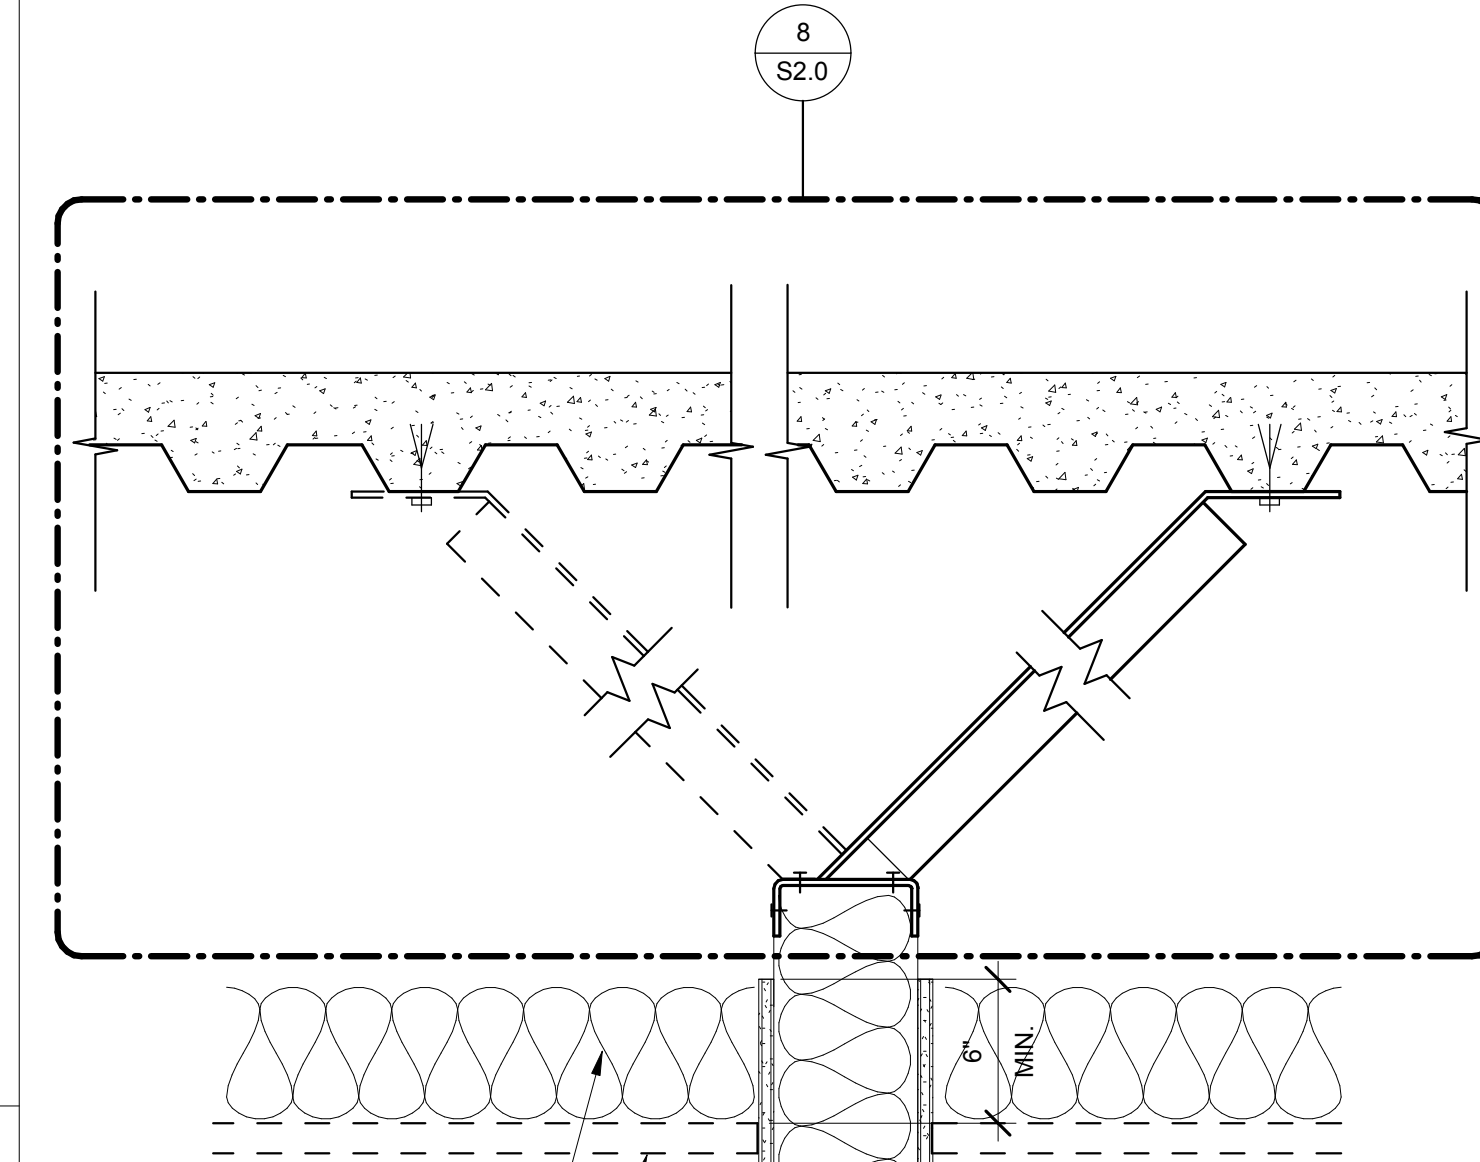


TYP. INT. PARTITION WALL PARTIAL HEIGHT 1
1 1/2" = 1'-0"

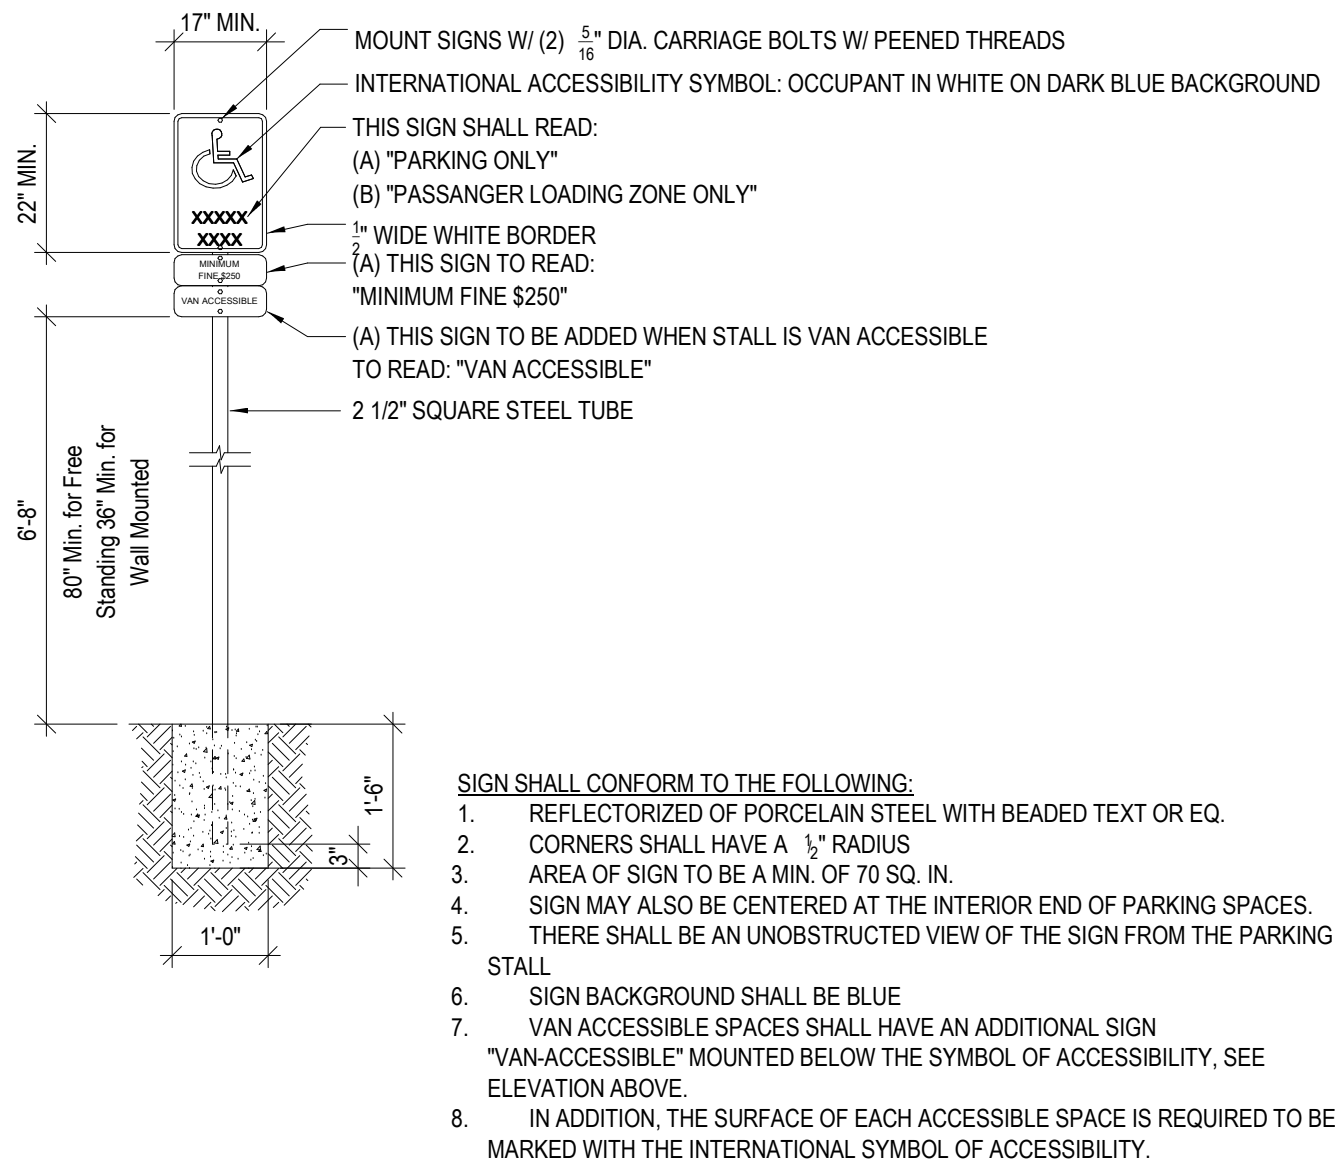


ACCESSIBLE STALL SIGNAGE 9
1/2" = 1'-0"

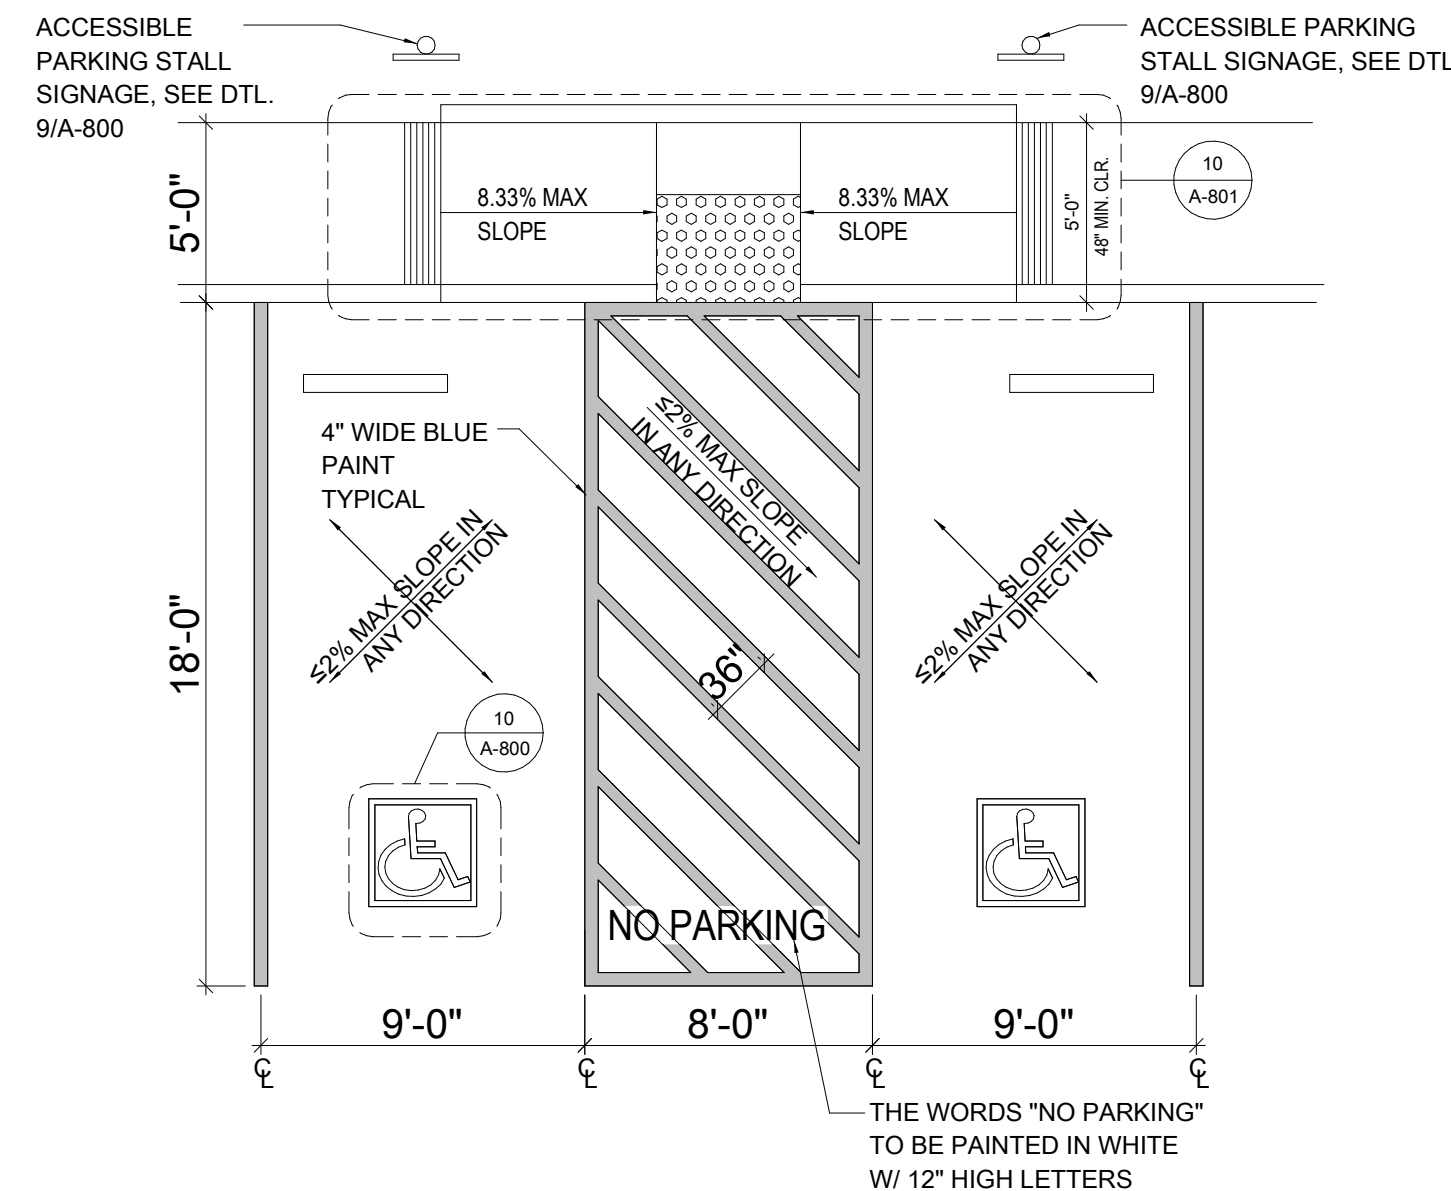

ACCESSIBLE PARKING STALL 6
3/16" = 1'-0"

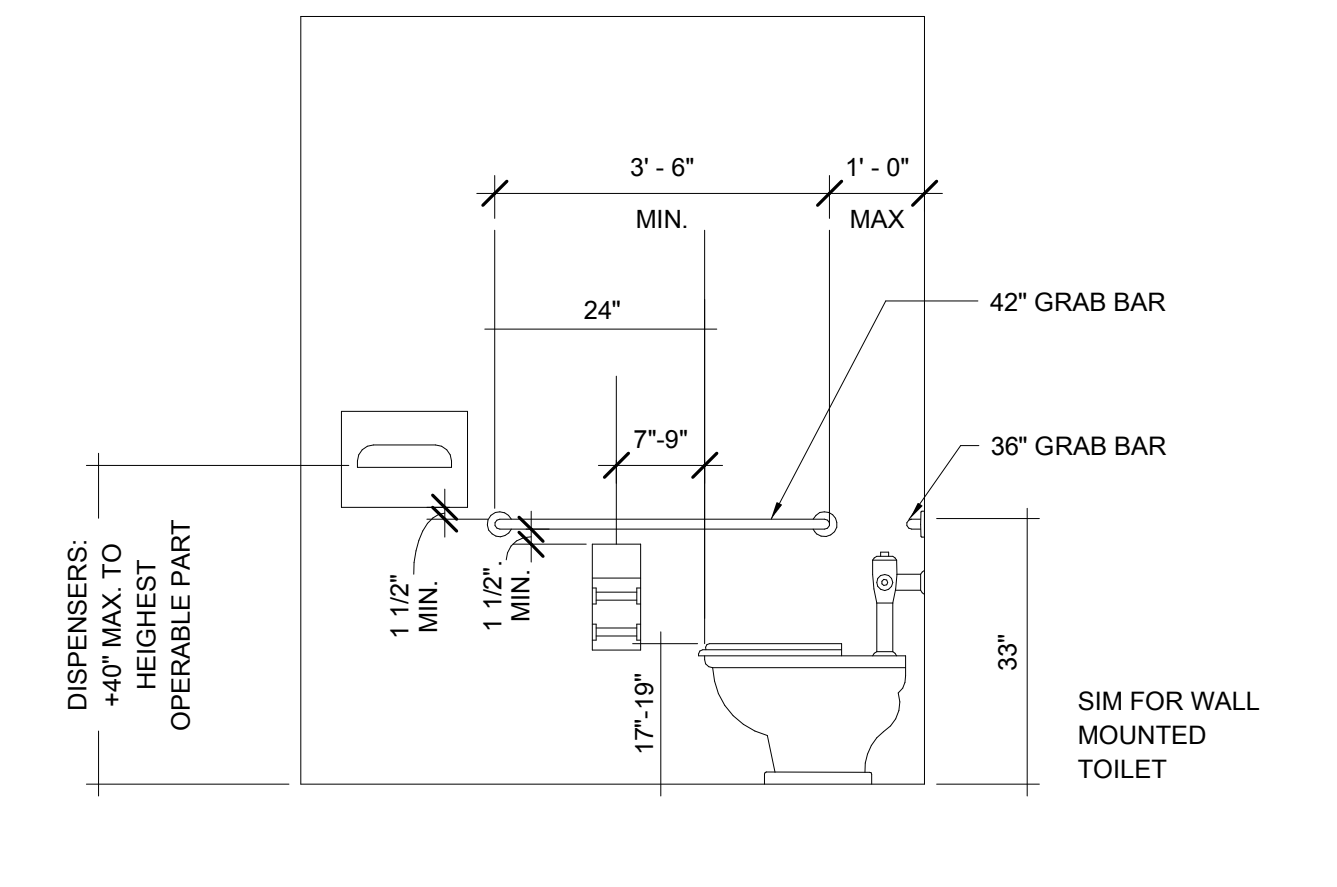


GRAB BAR ELEVATION 4
1/2" = 1'-0"

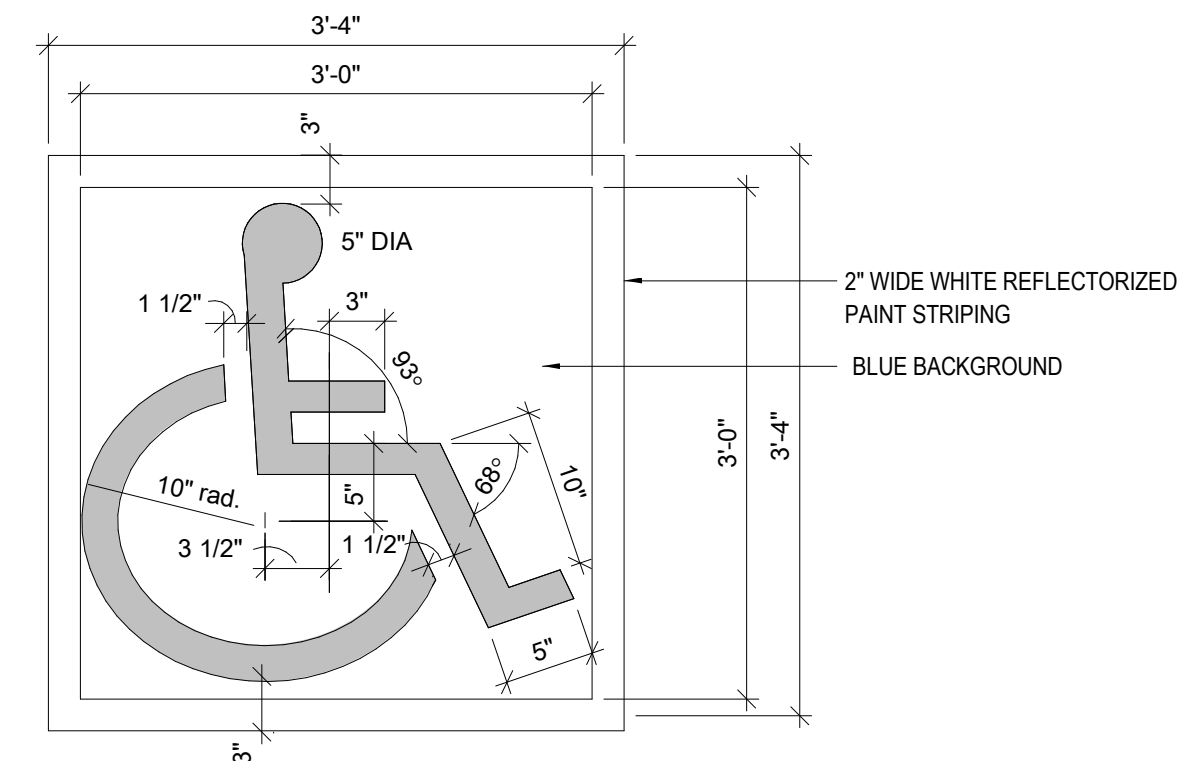


- NOTES**
1. SYMBOL PAINTED HIGHWAY WHITE (TWO COATS).
 2. BACKGROUND PAINTED BLUE OR EQUAL TO COLOR #15090 IN FED. STD. 595A
 3. STENCIL ON SYMBOL ONTO PARKING SURFACE IN EACH ACCESSIBLE STALL.
 4. LOCATE PER ACCESSIBLE PARKING STALL DETAILS.

DISABLED PARKING SIGNAGE 10
1" = 1'-0"

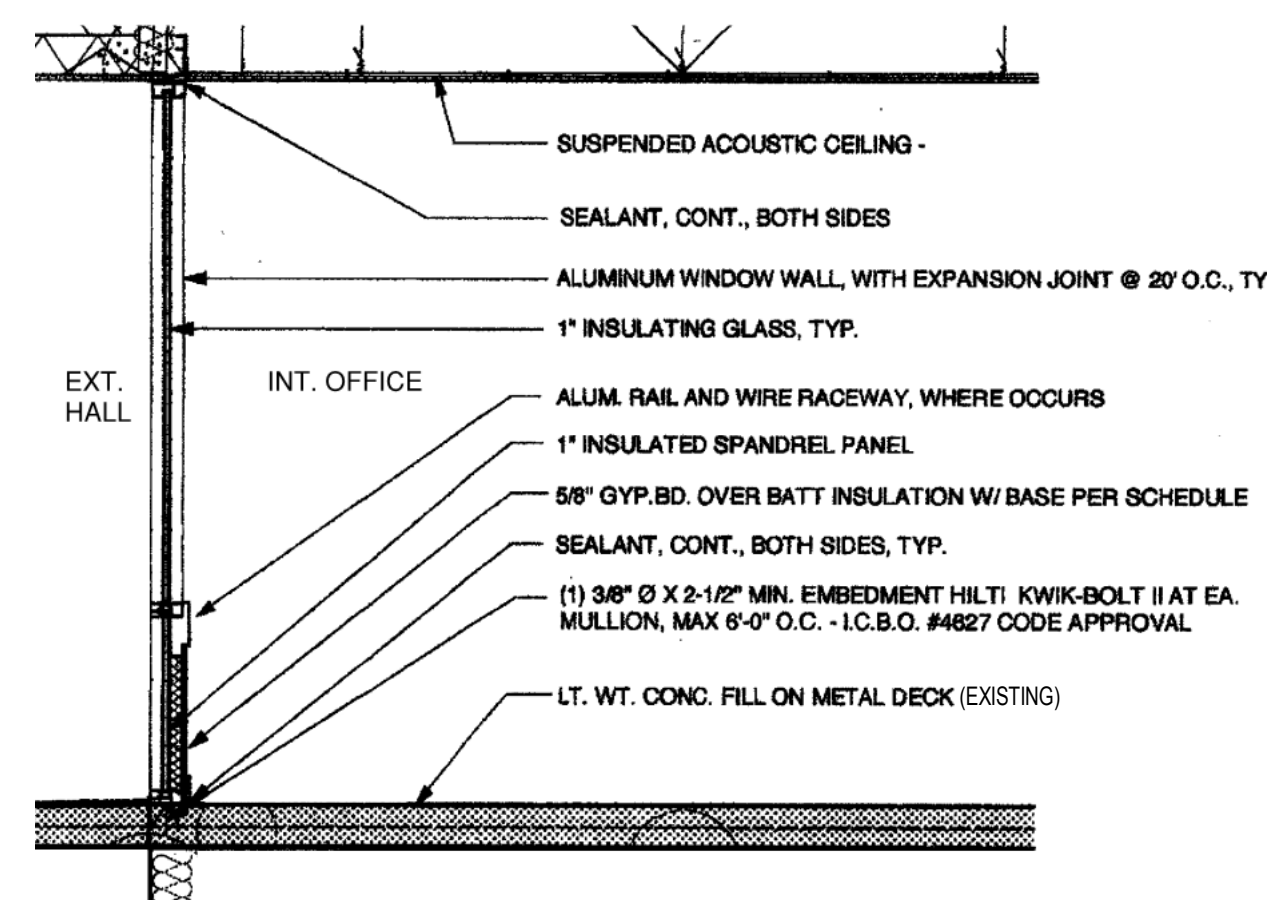

STOREFRONT AND SHORTWALL DETAIL 5
1 1/2" = 1'-0"

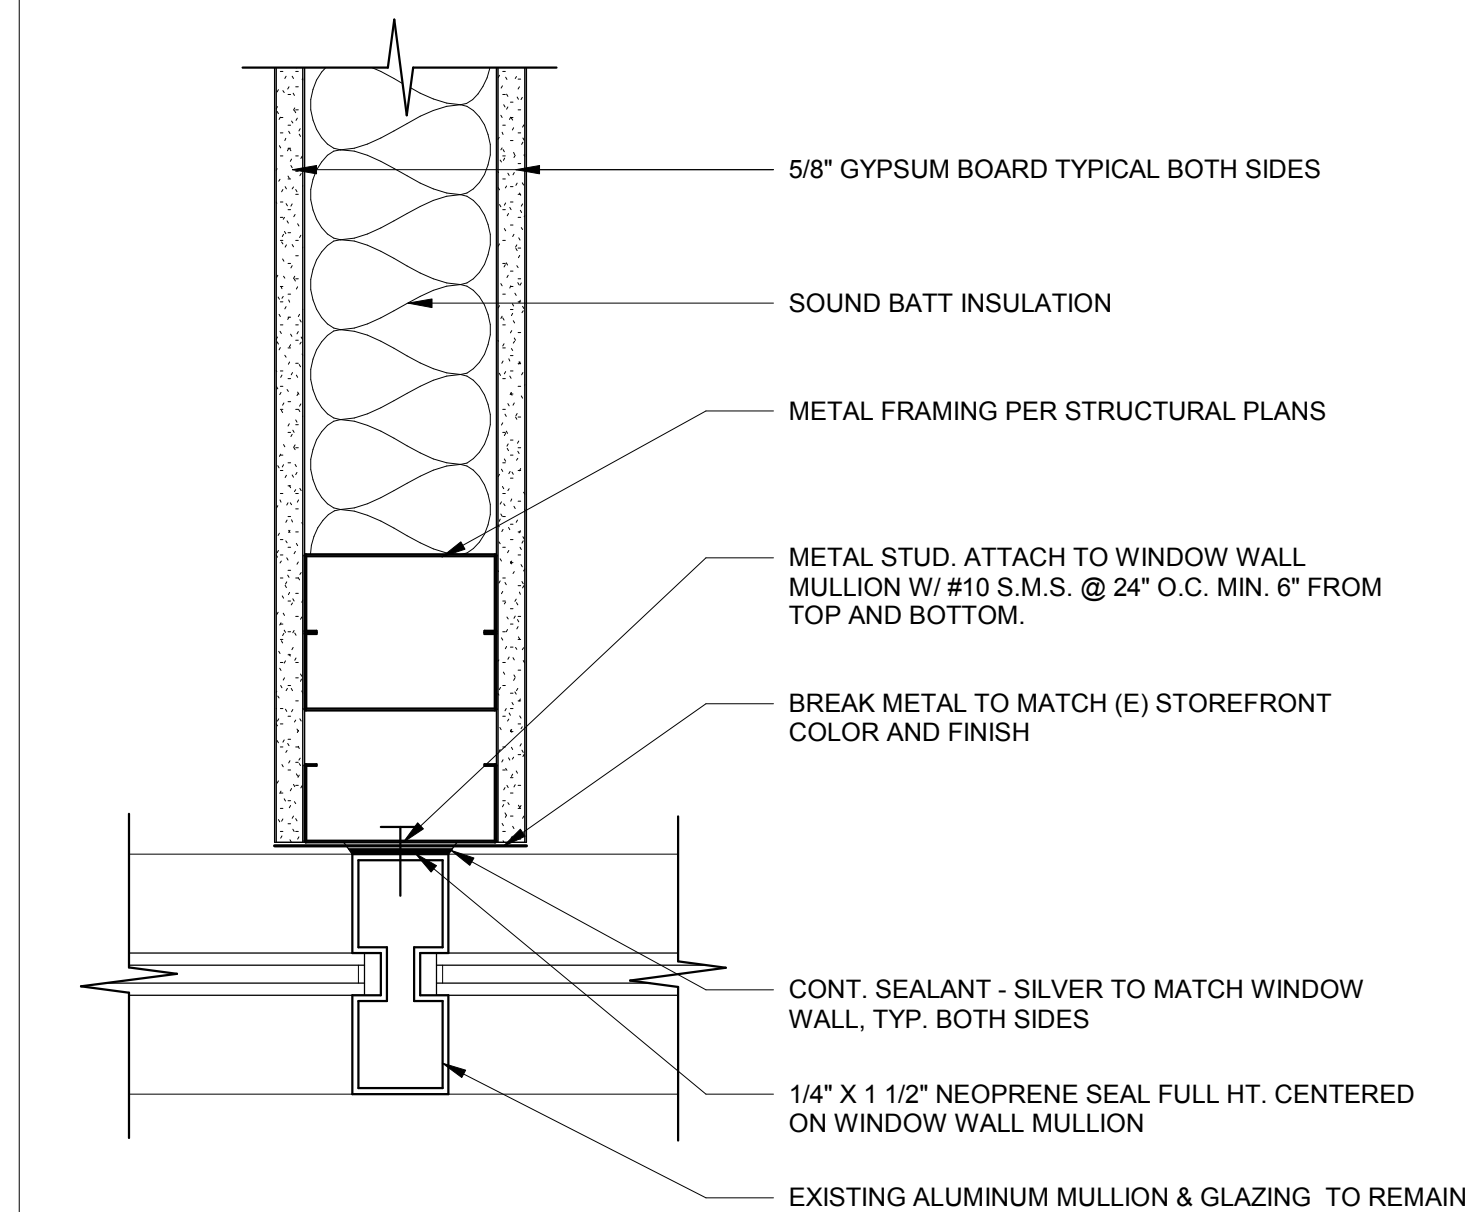

INT. PARTITION WALL TO STOREFRONT MULLION 2
3" = 1'-0"

CLIENT



Palo Verde Community College District
1 College Drive
Blythe, CA 92225

PROJECT NAME

Project 2
College Services Building
1 College Drive
Blythe, CA 92225

CONTRACTOR

DESIGNER



CONSULTANTS

REGISTRATION STAMP



ISSUE

Mark	Date	Description
Δ	3/24/2018	ADDENDUM 2

DESIGNER PROJECT NO.: 17009

DRAWN BY: Author

CHECKED BY: Checker

SCALE: As indicated

DESIGN ITERATION 10/06/17

DSA Submittal 10/06/2017













DATE 10/06/17

SHEET TITLE

DETAILS

SHEET NUMBER

A-800

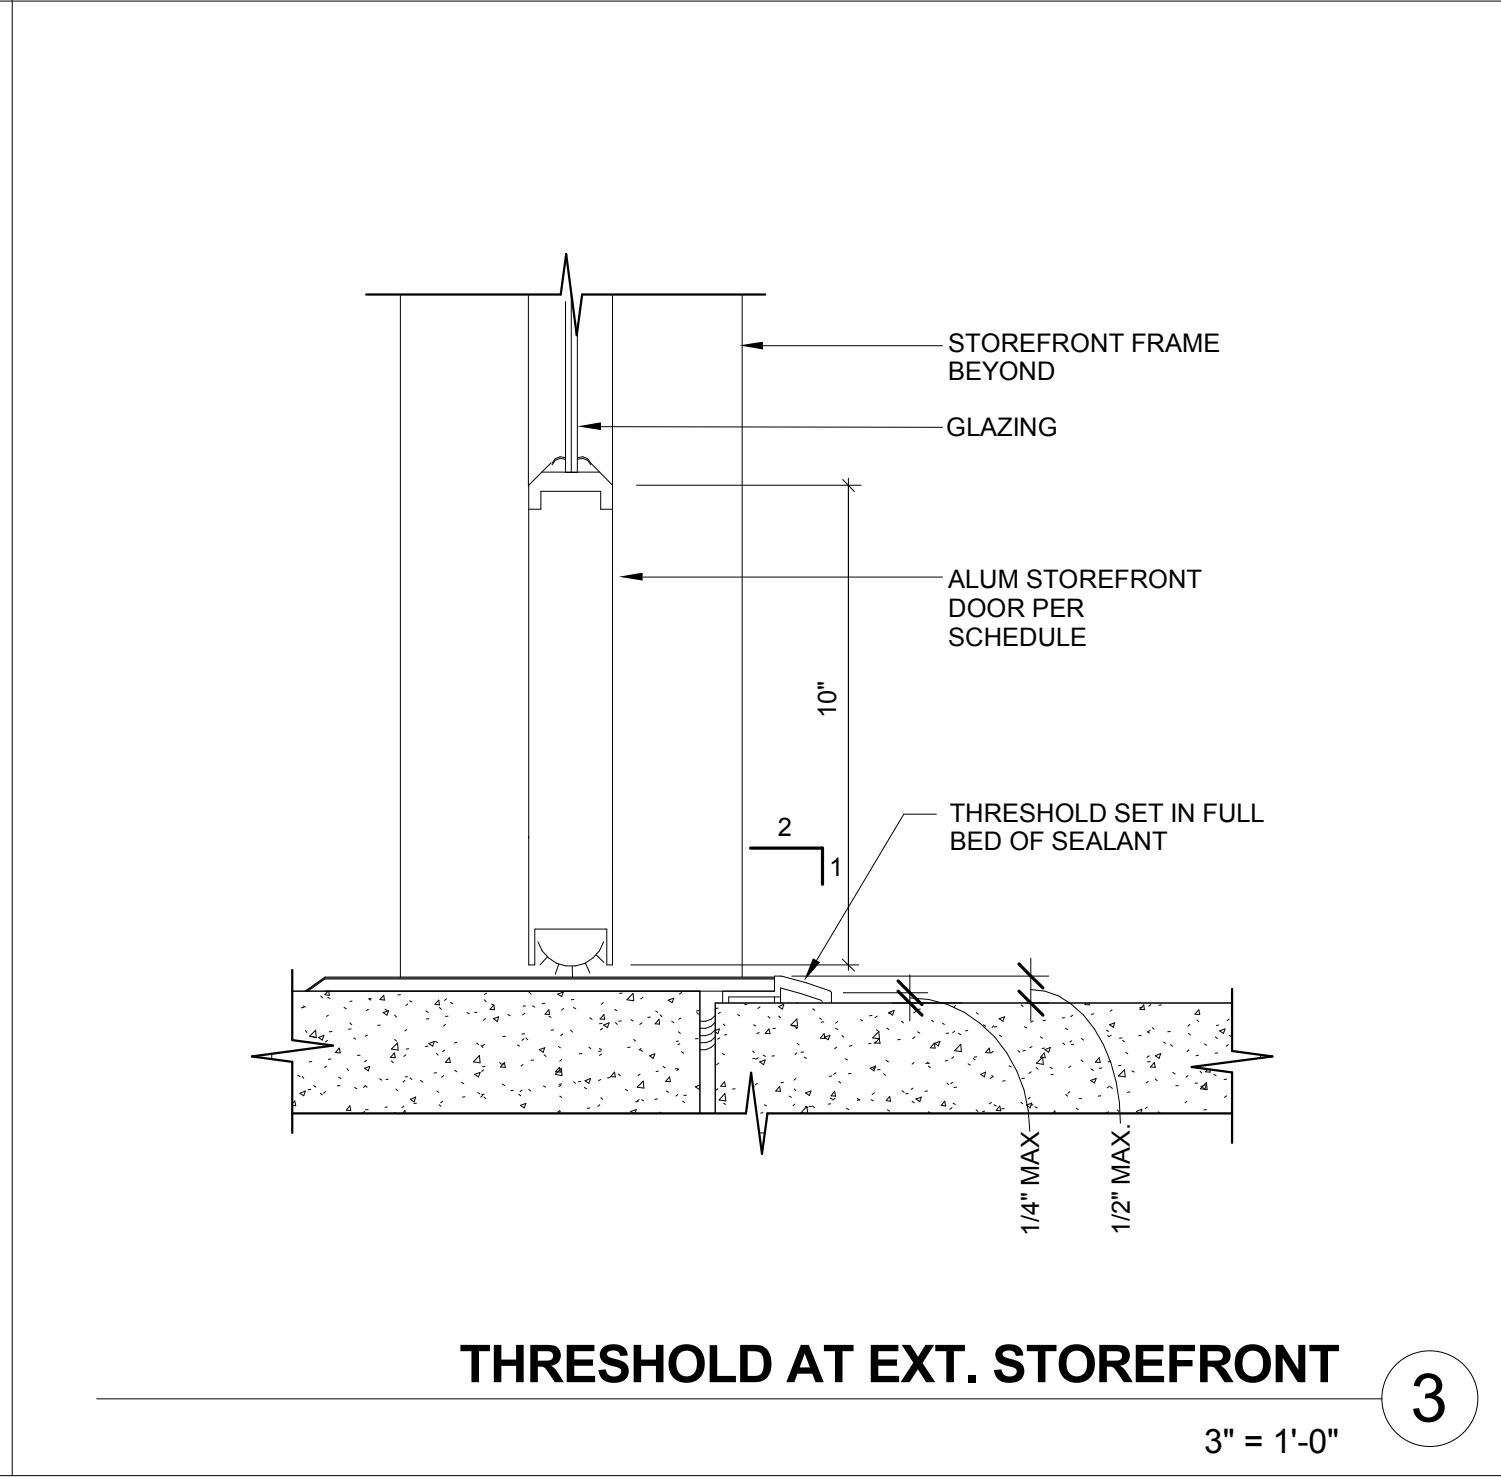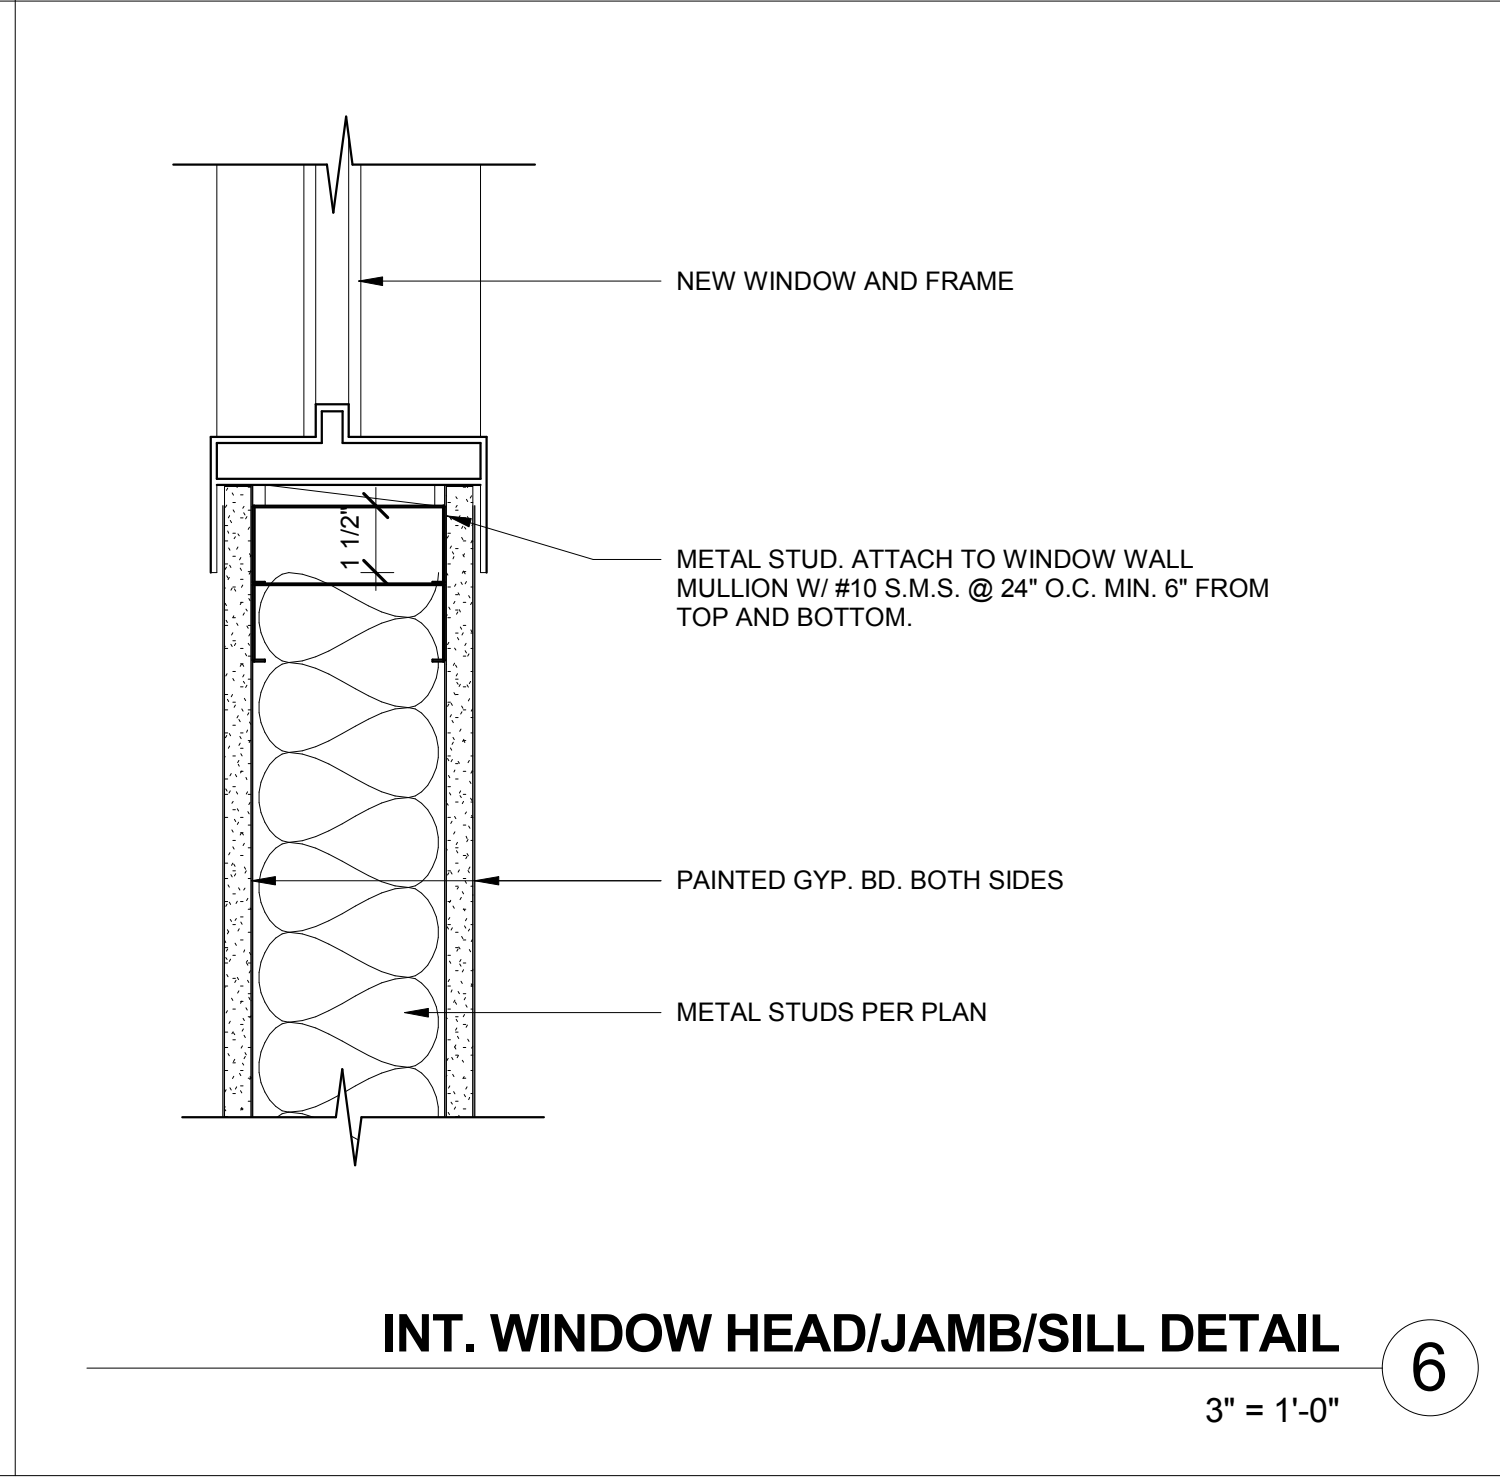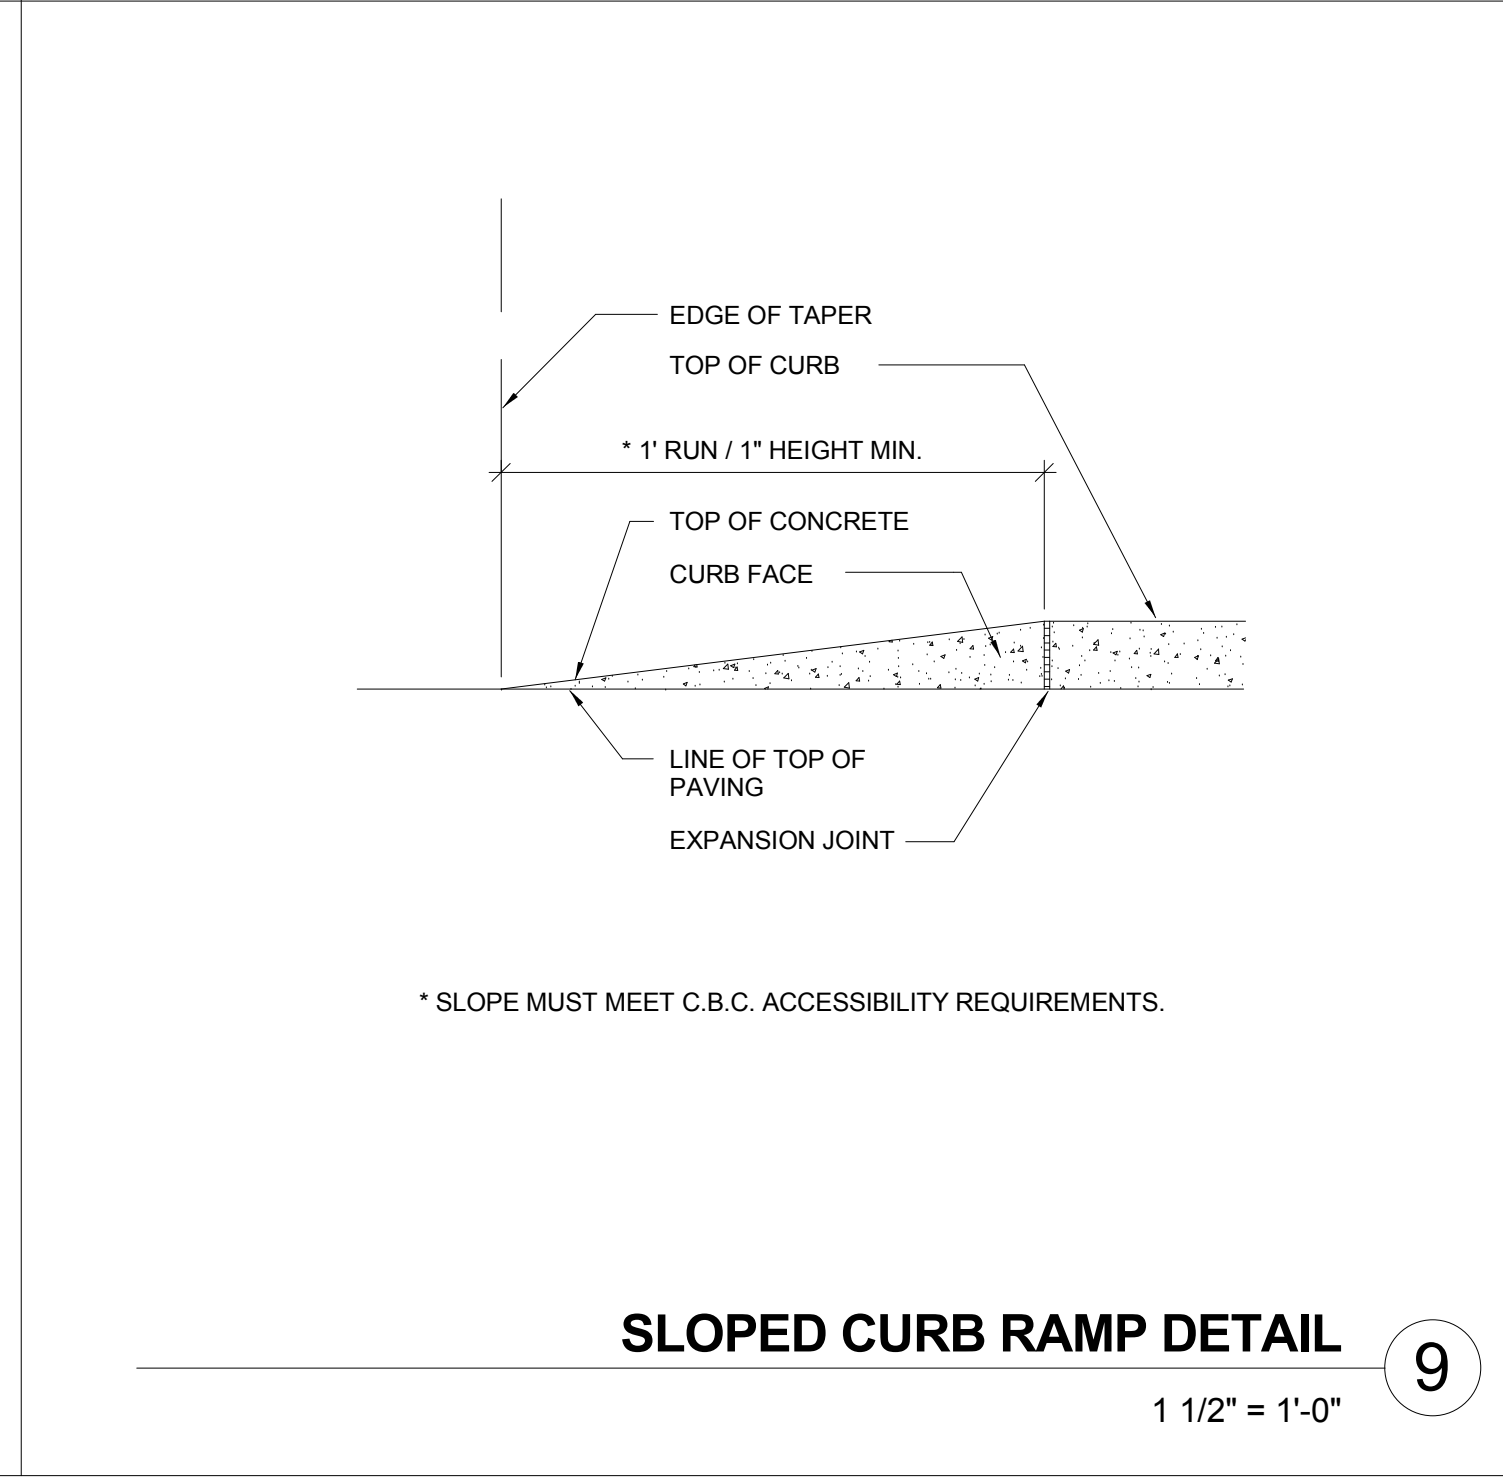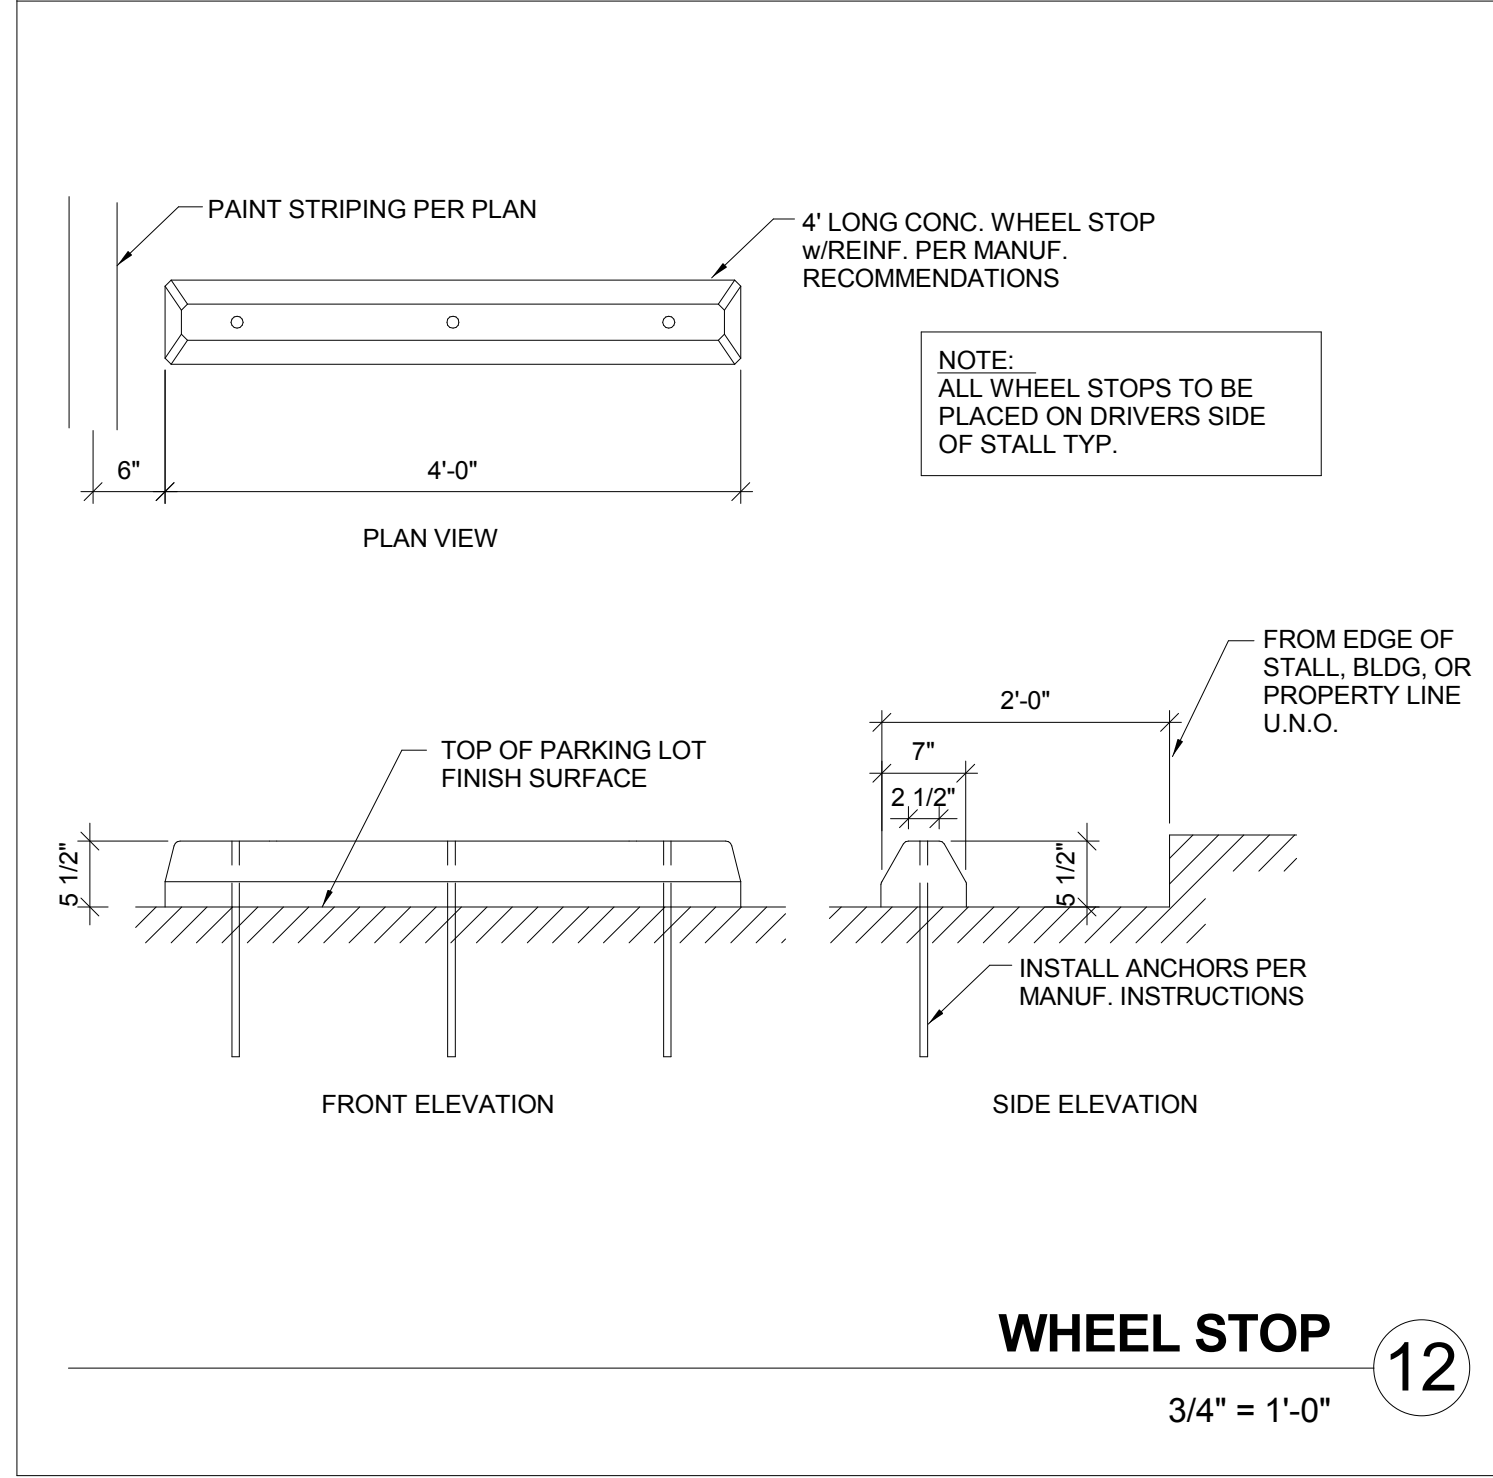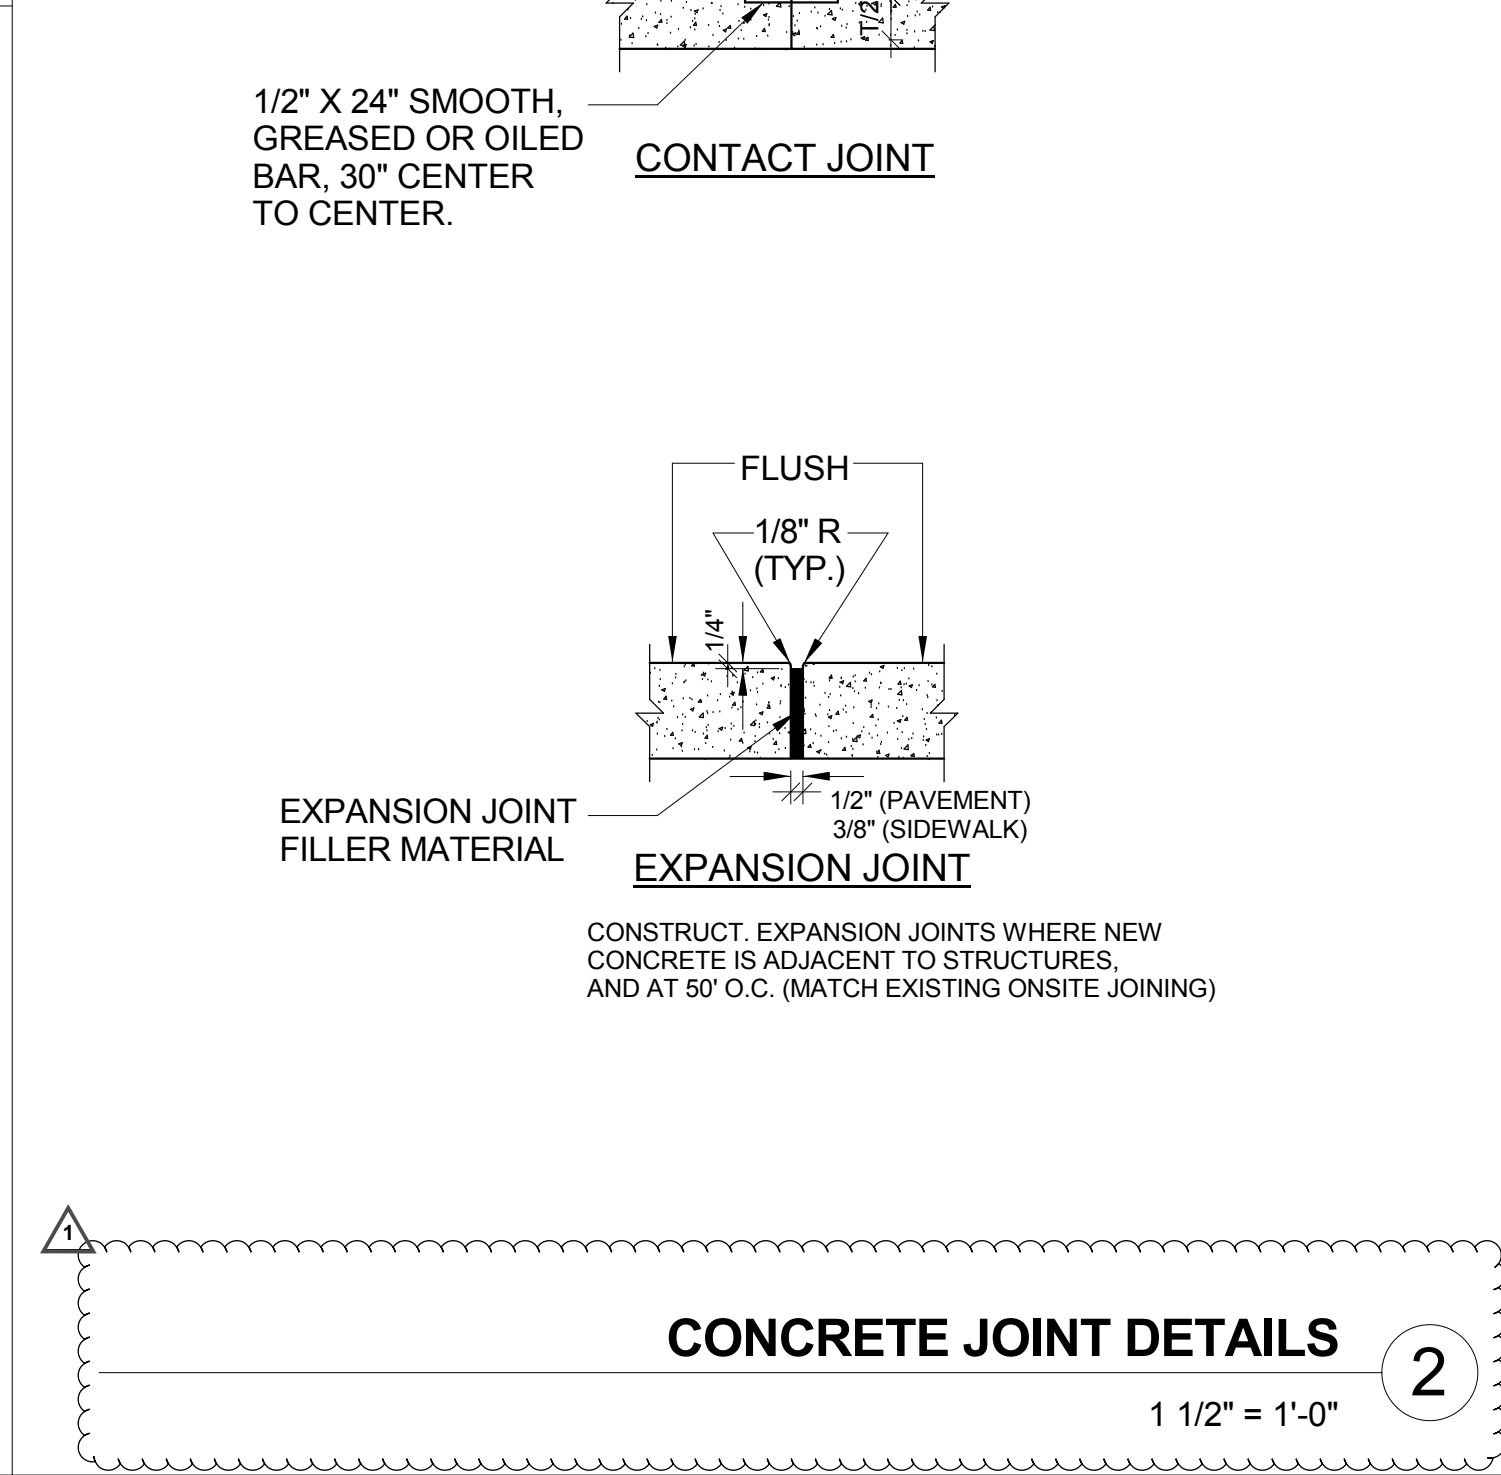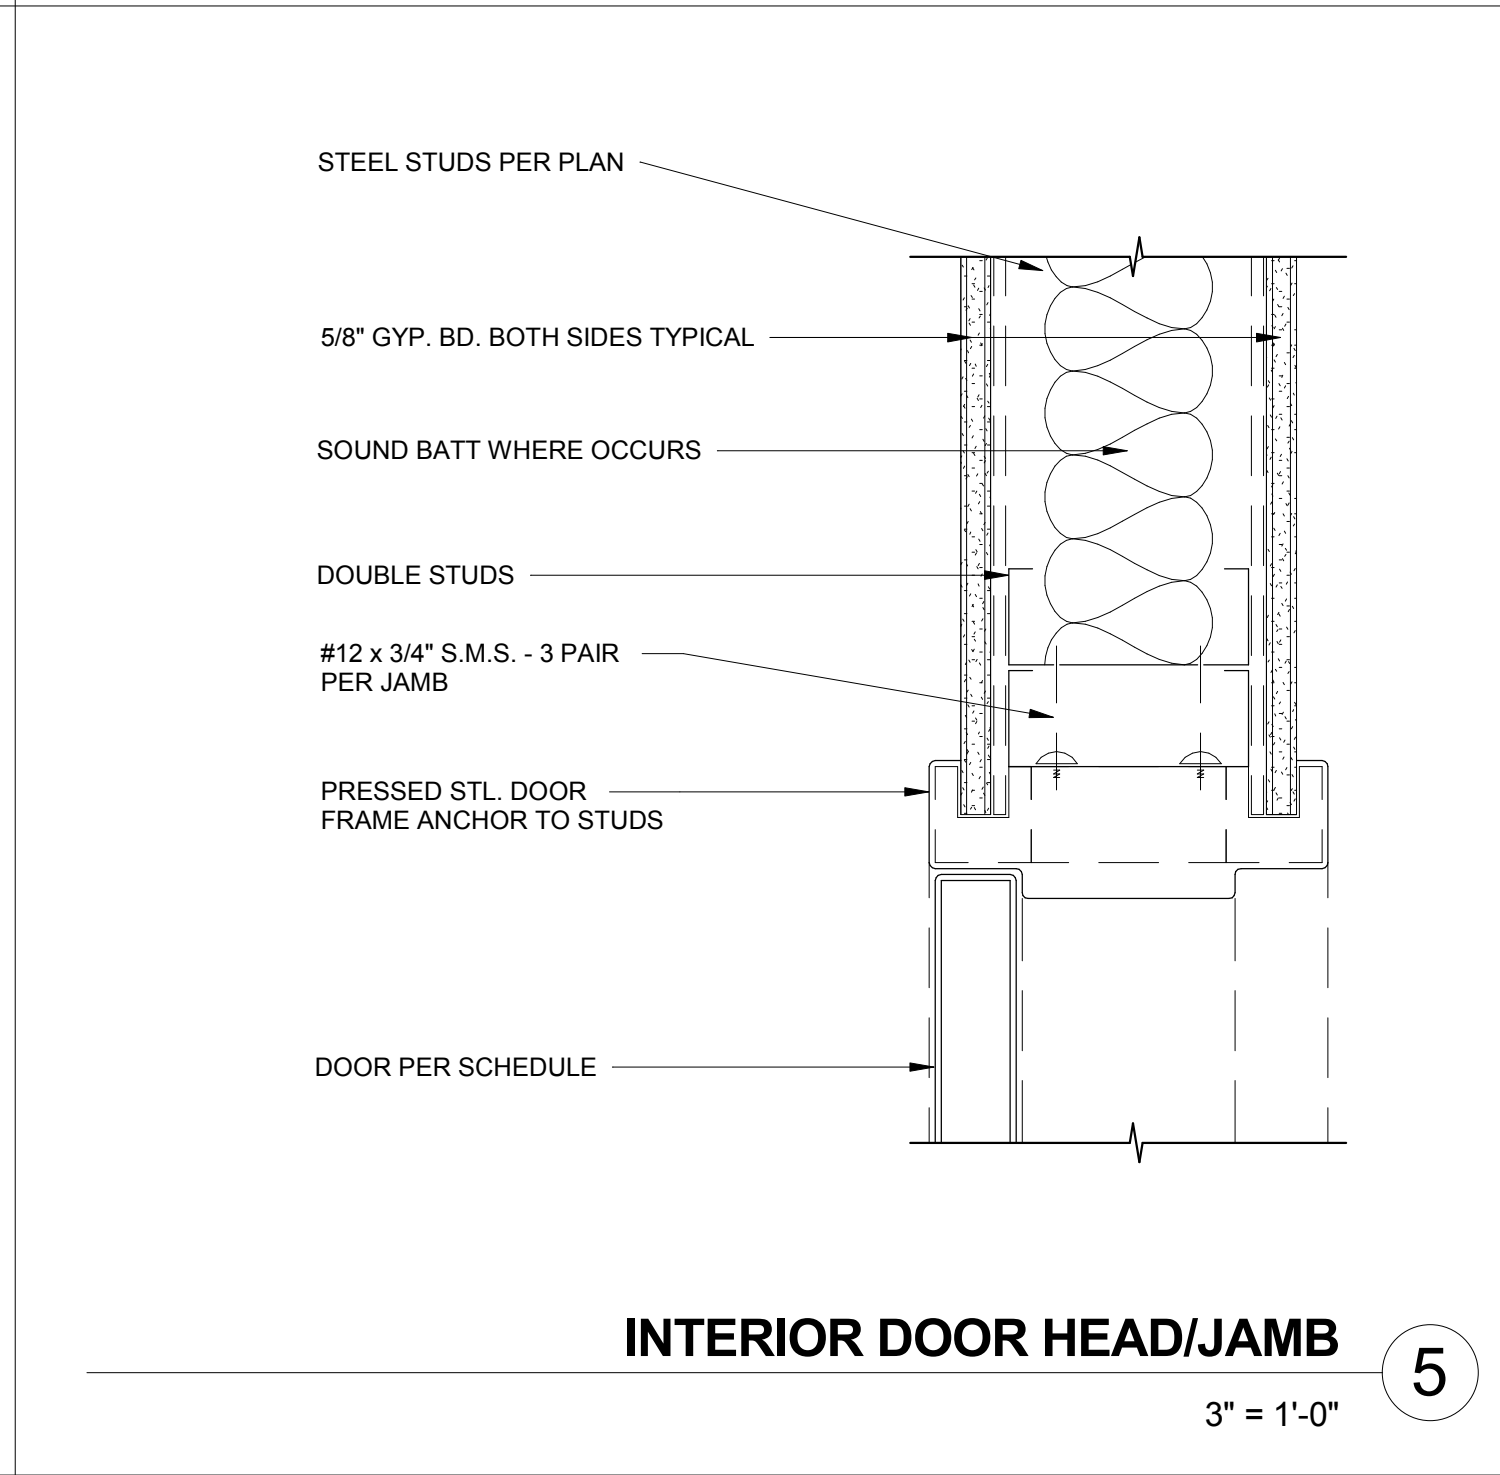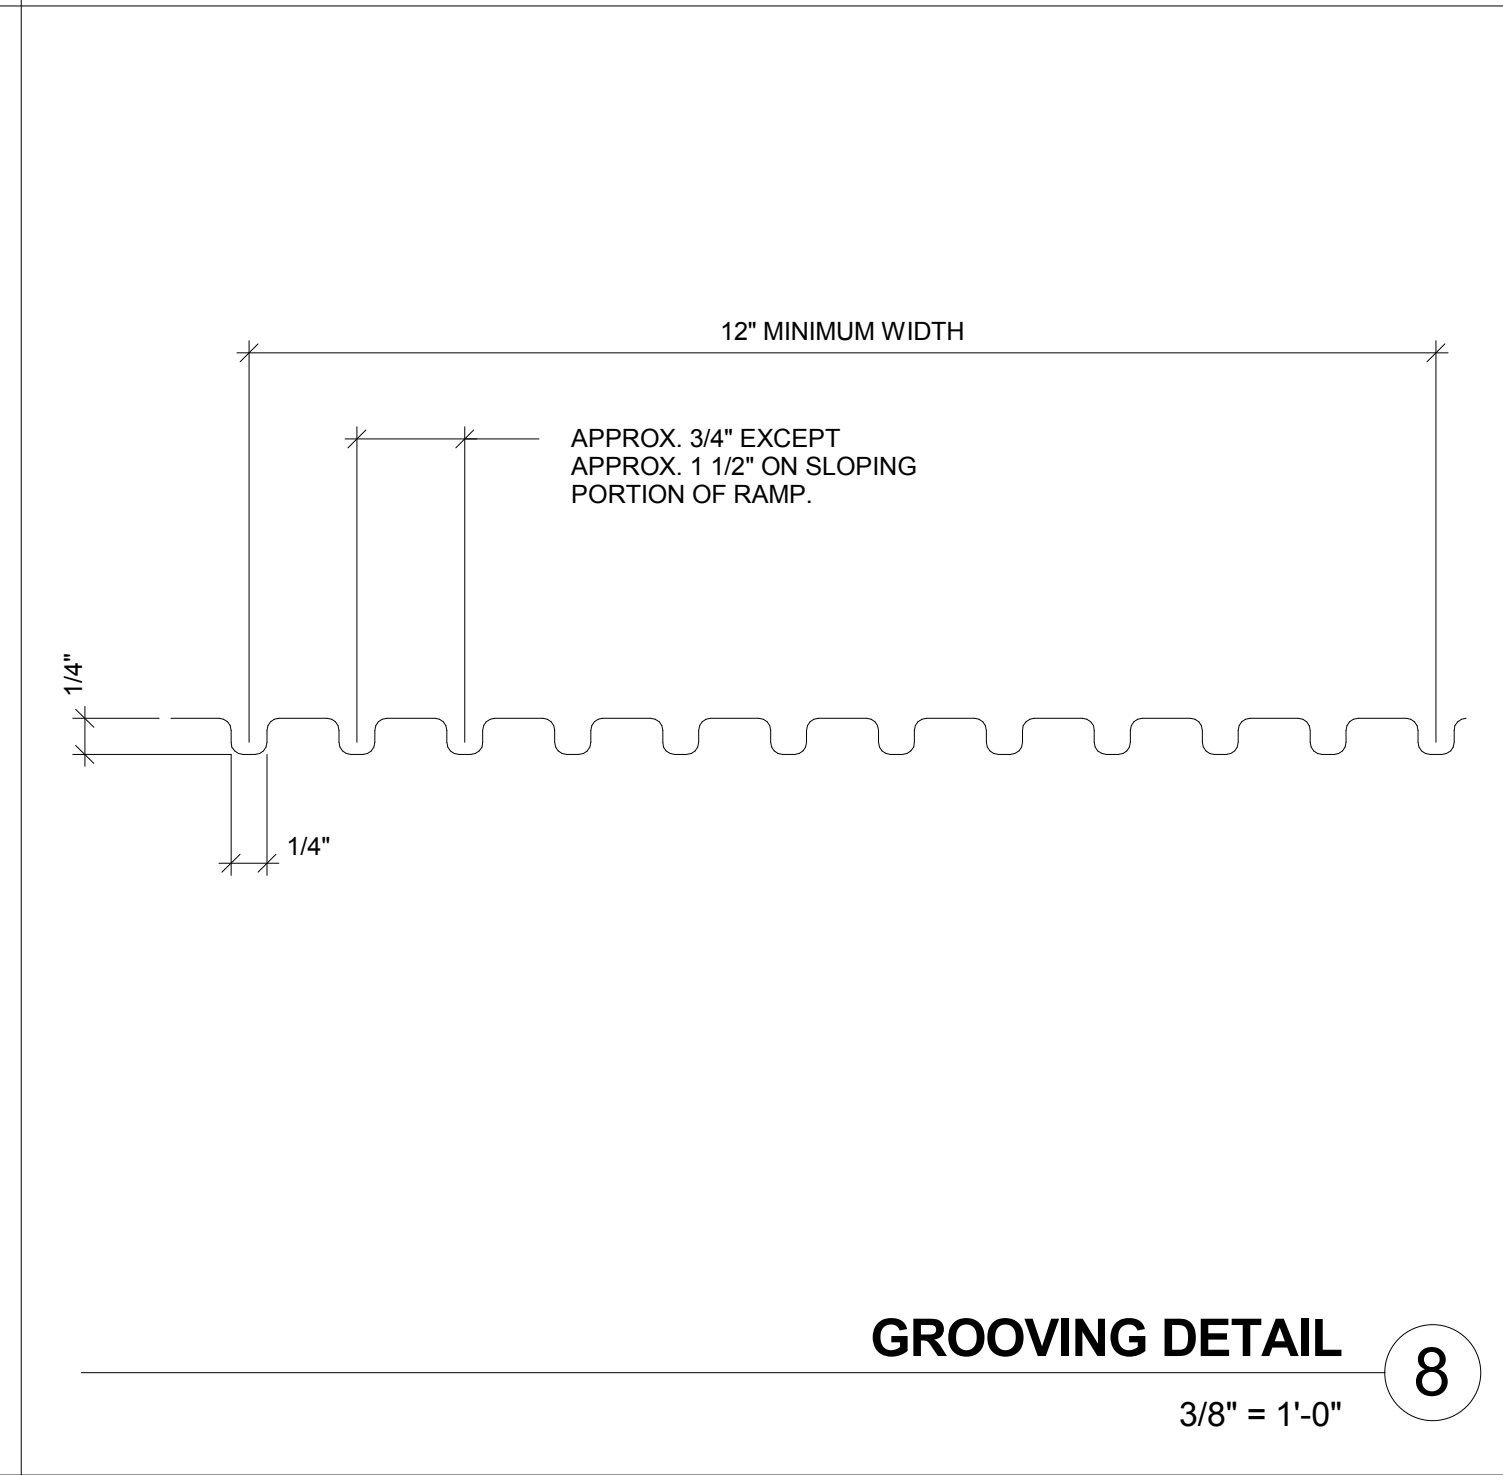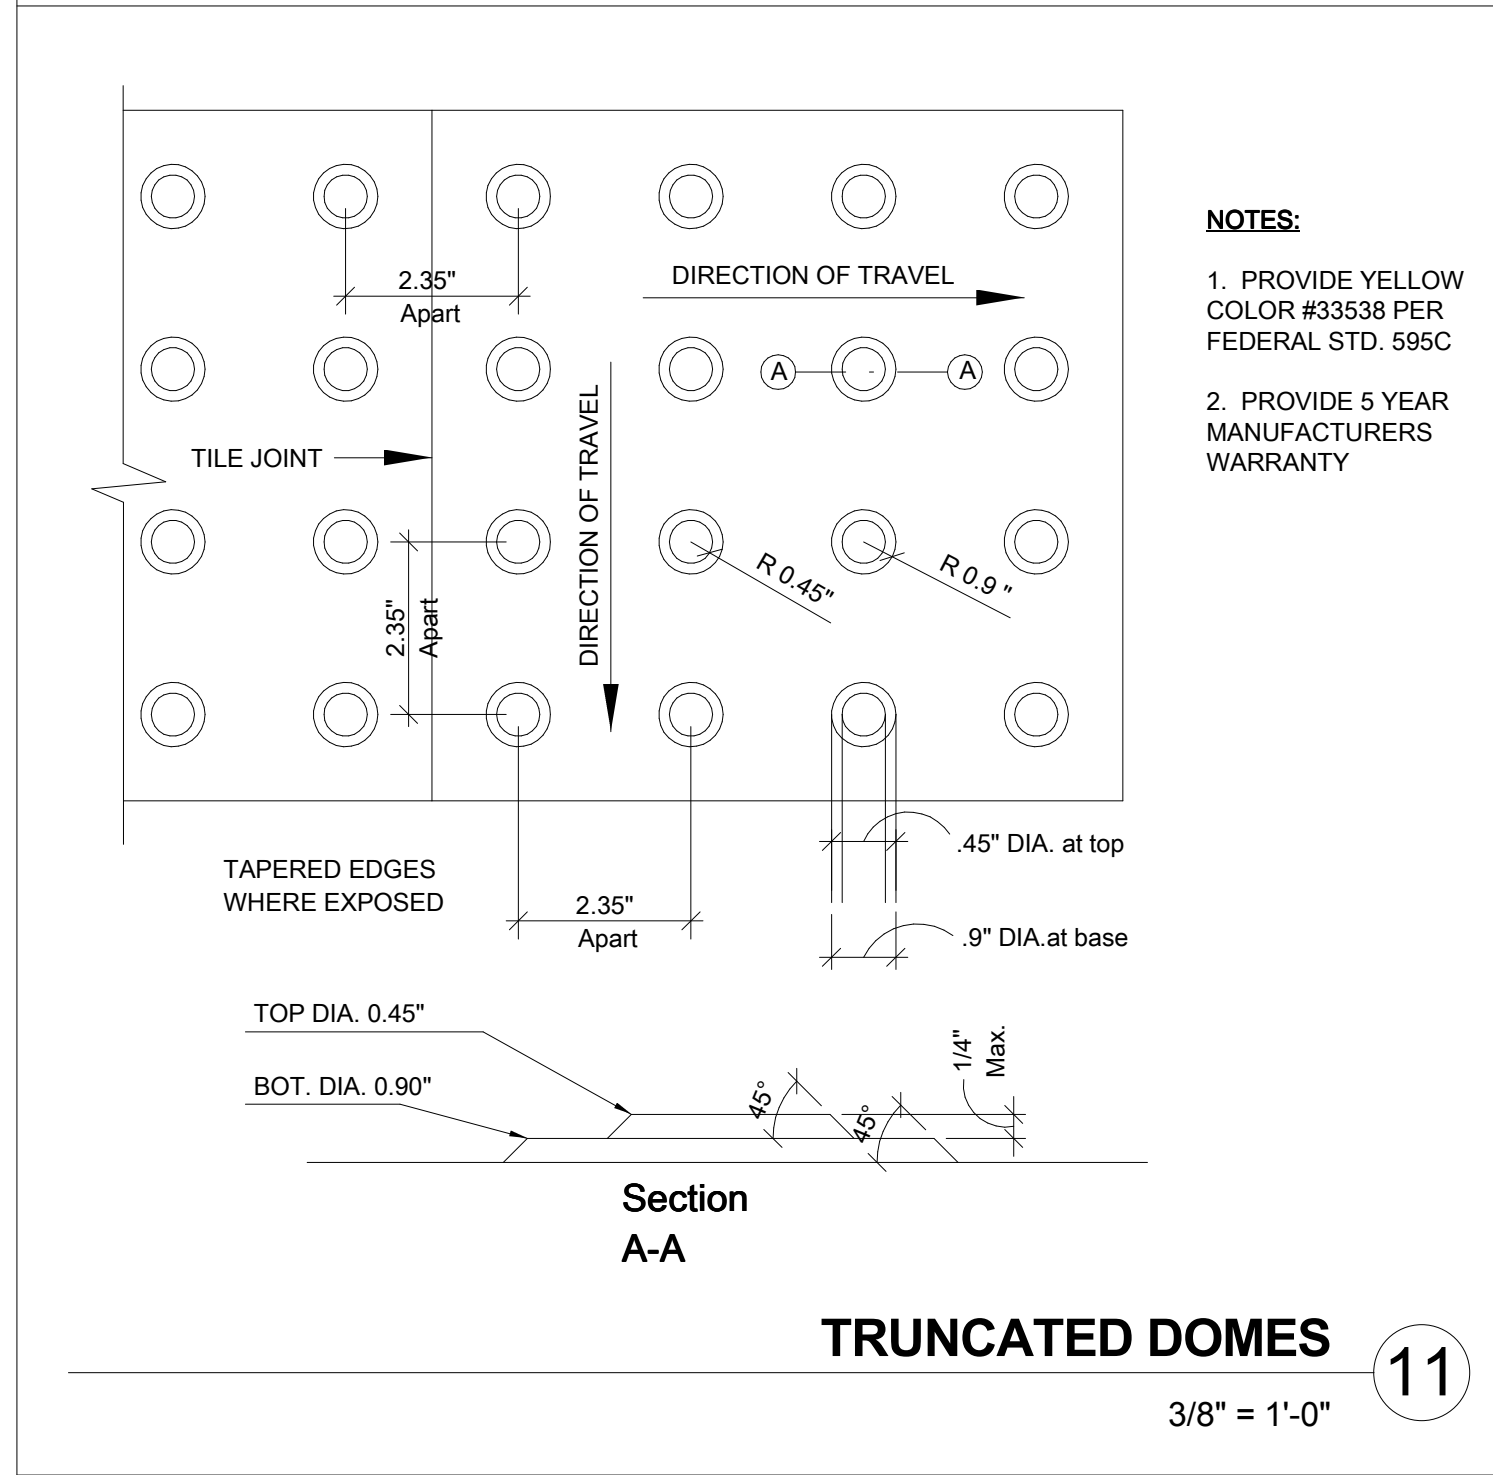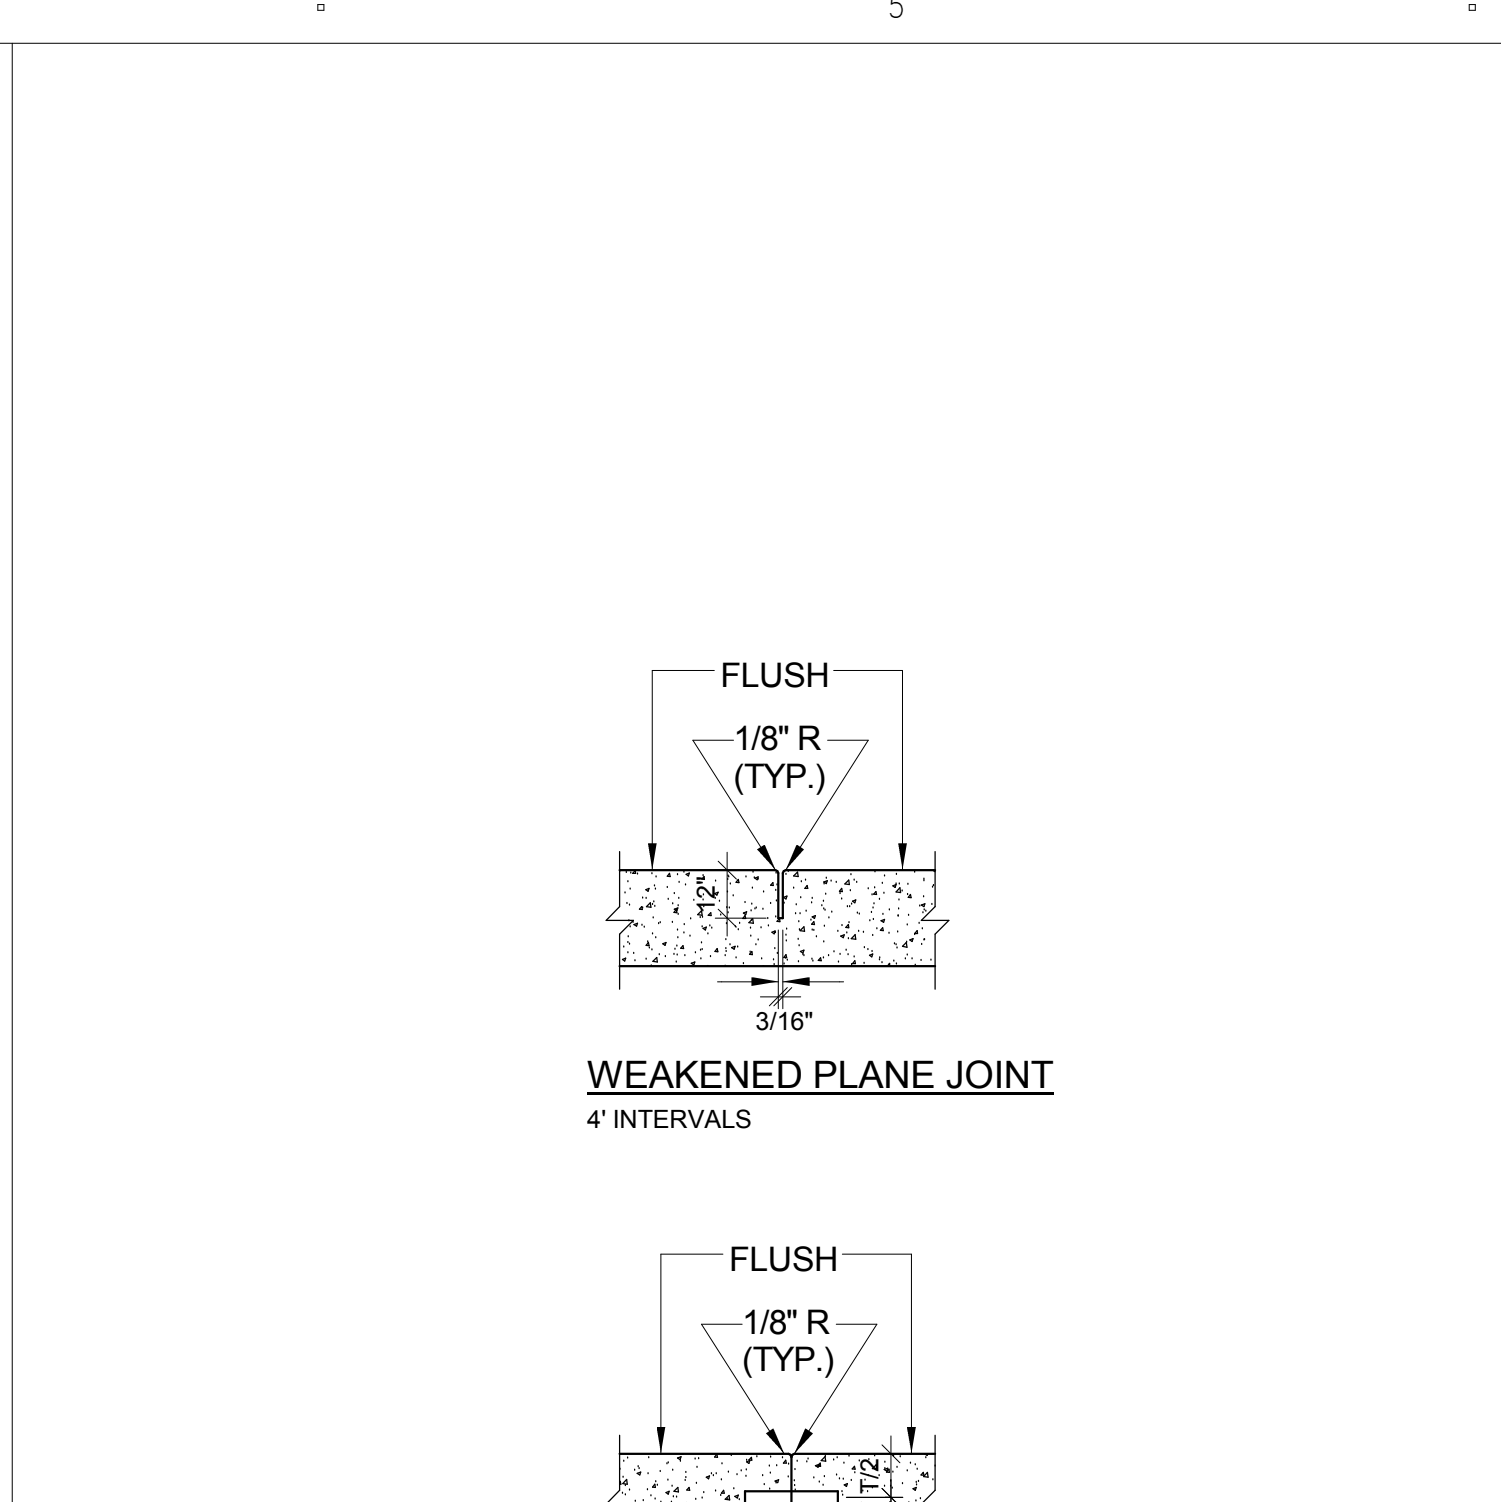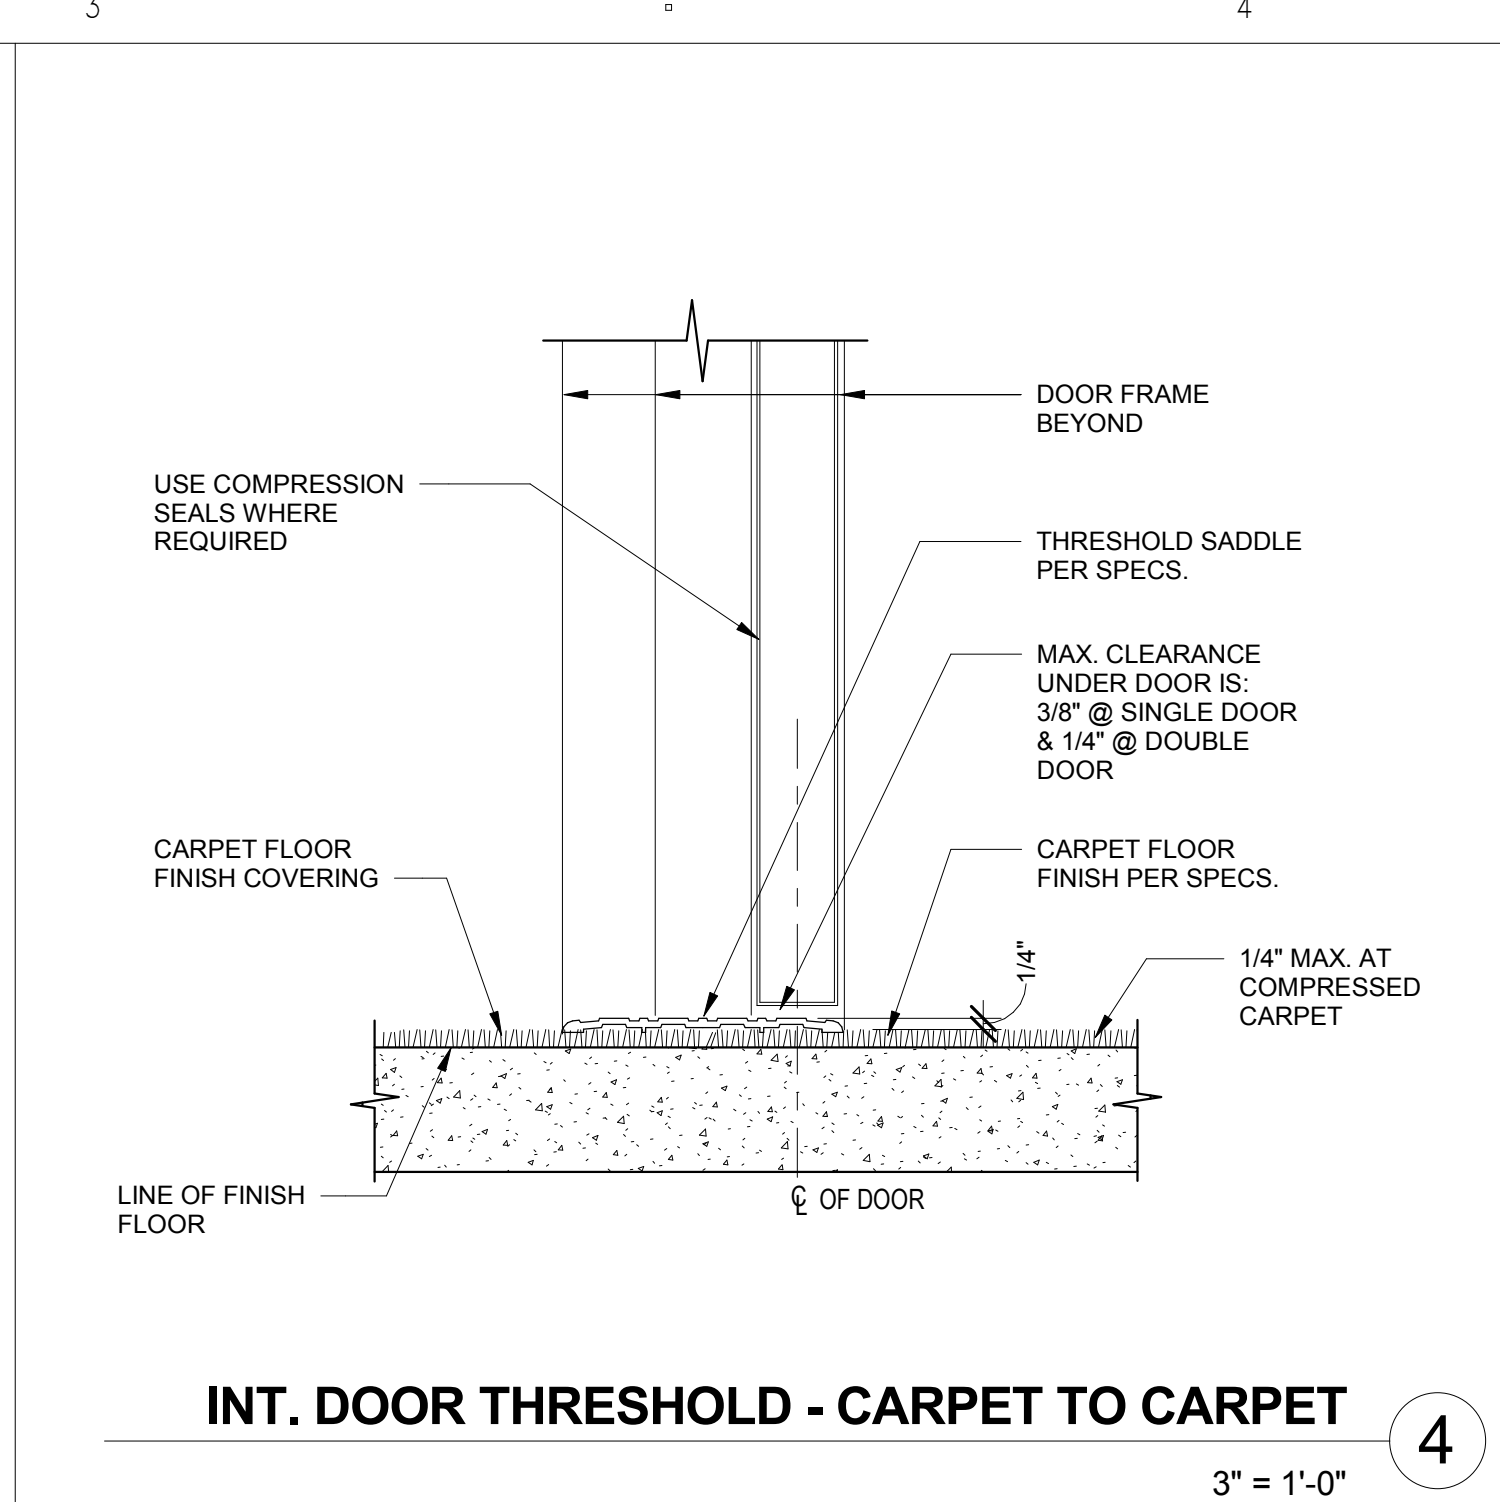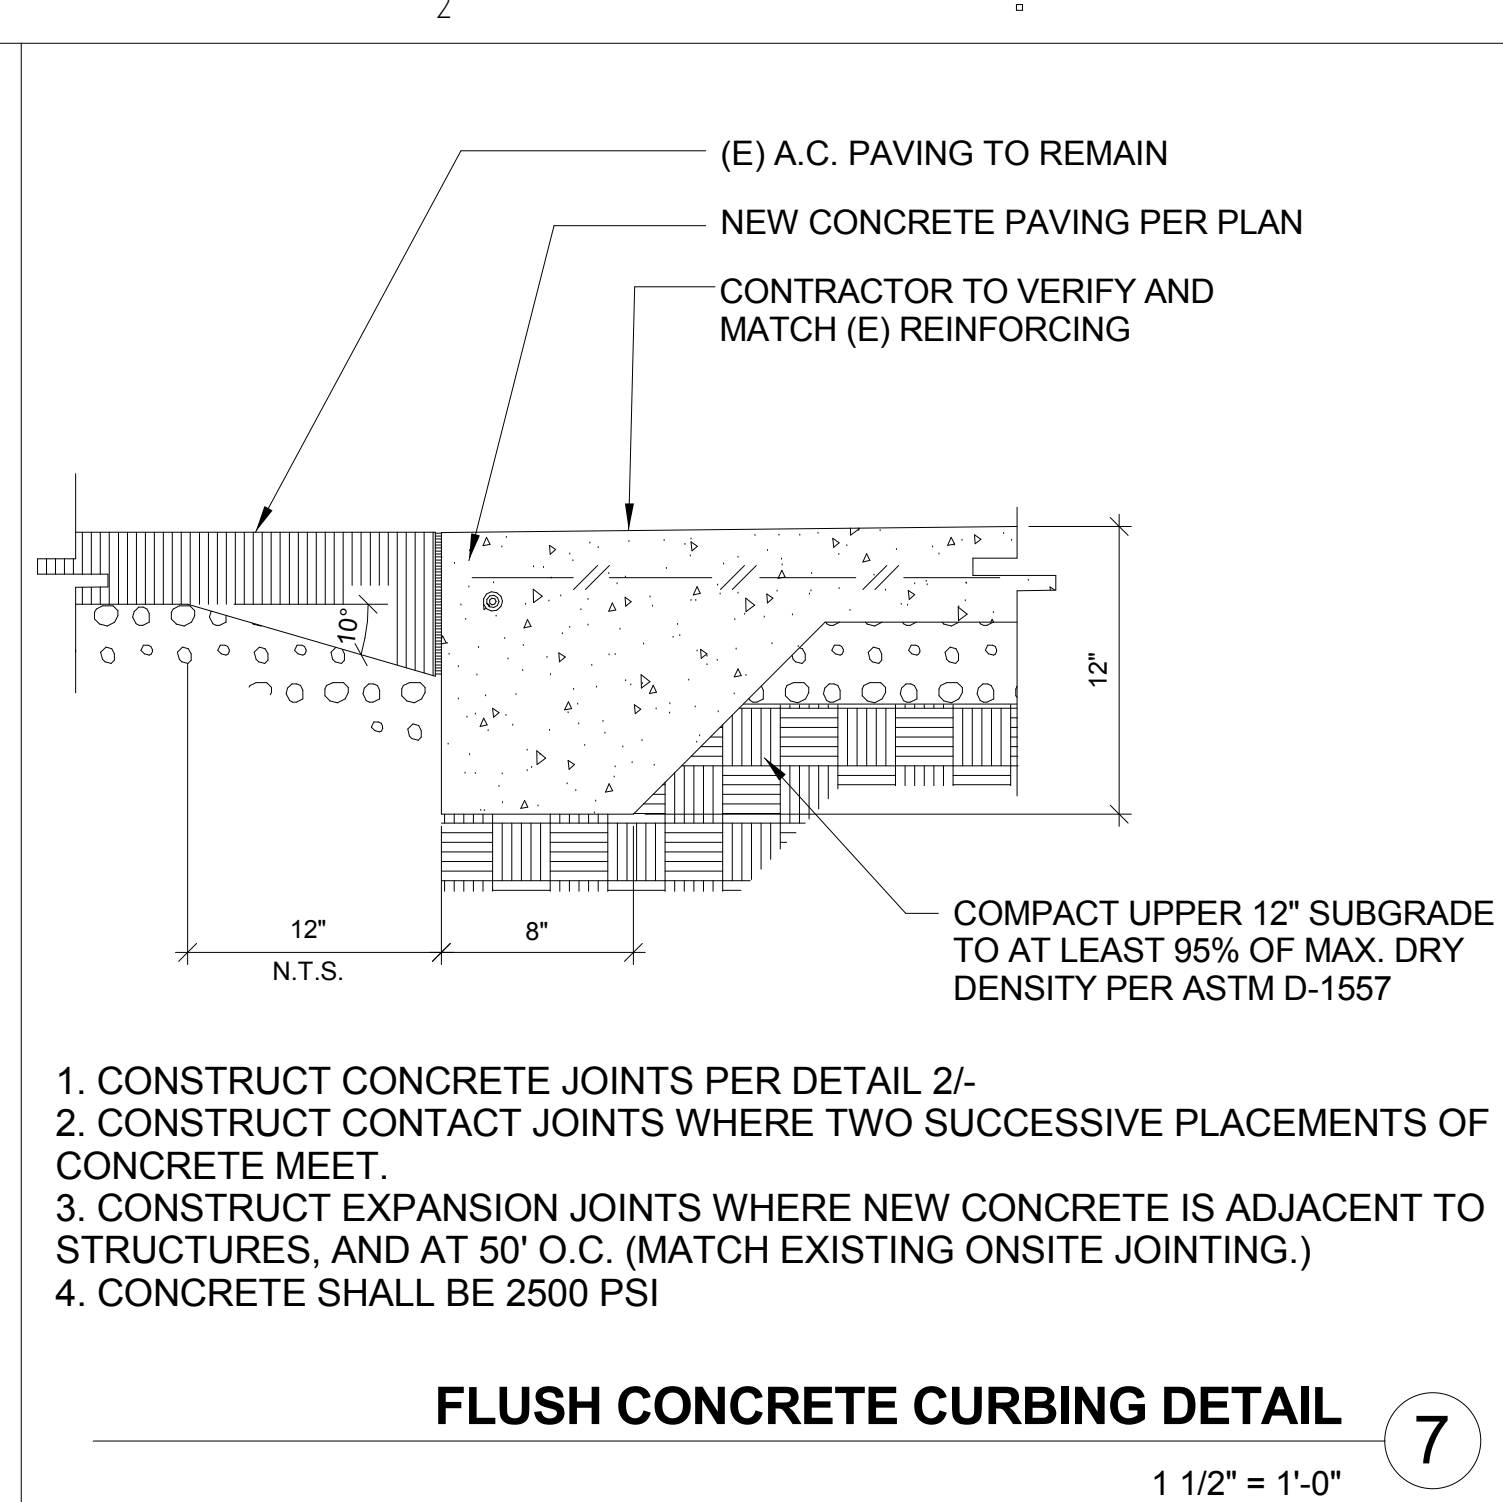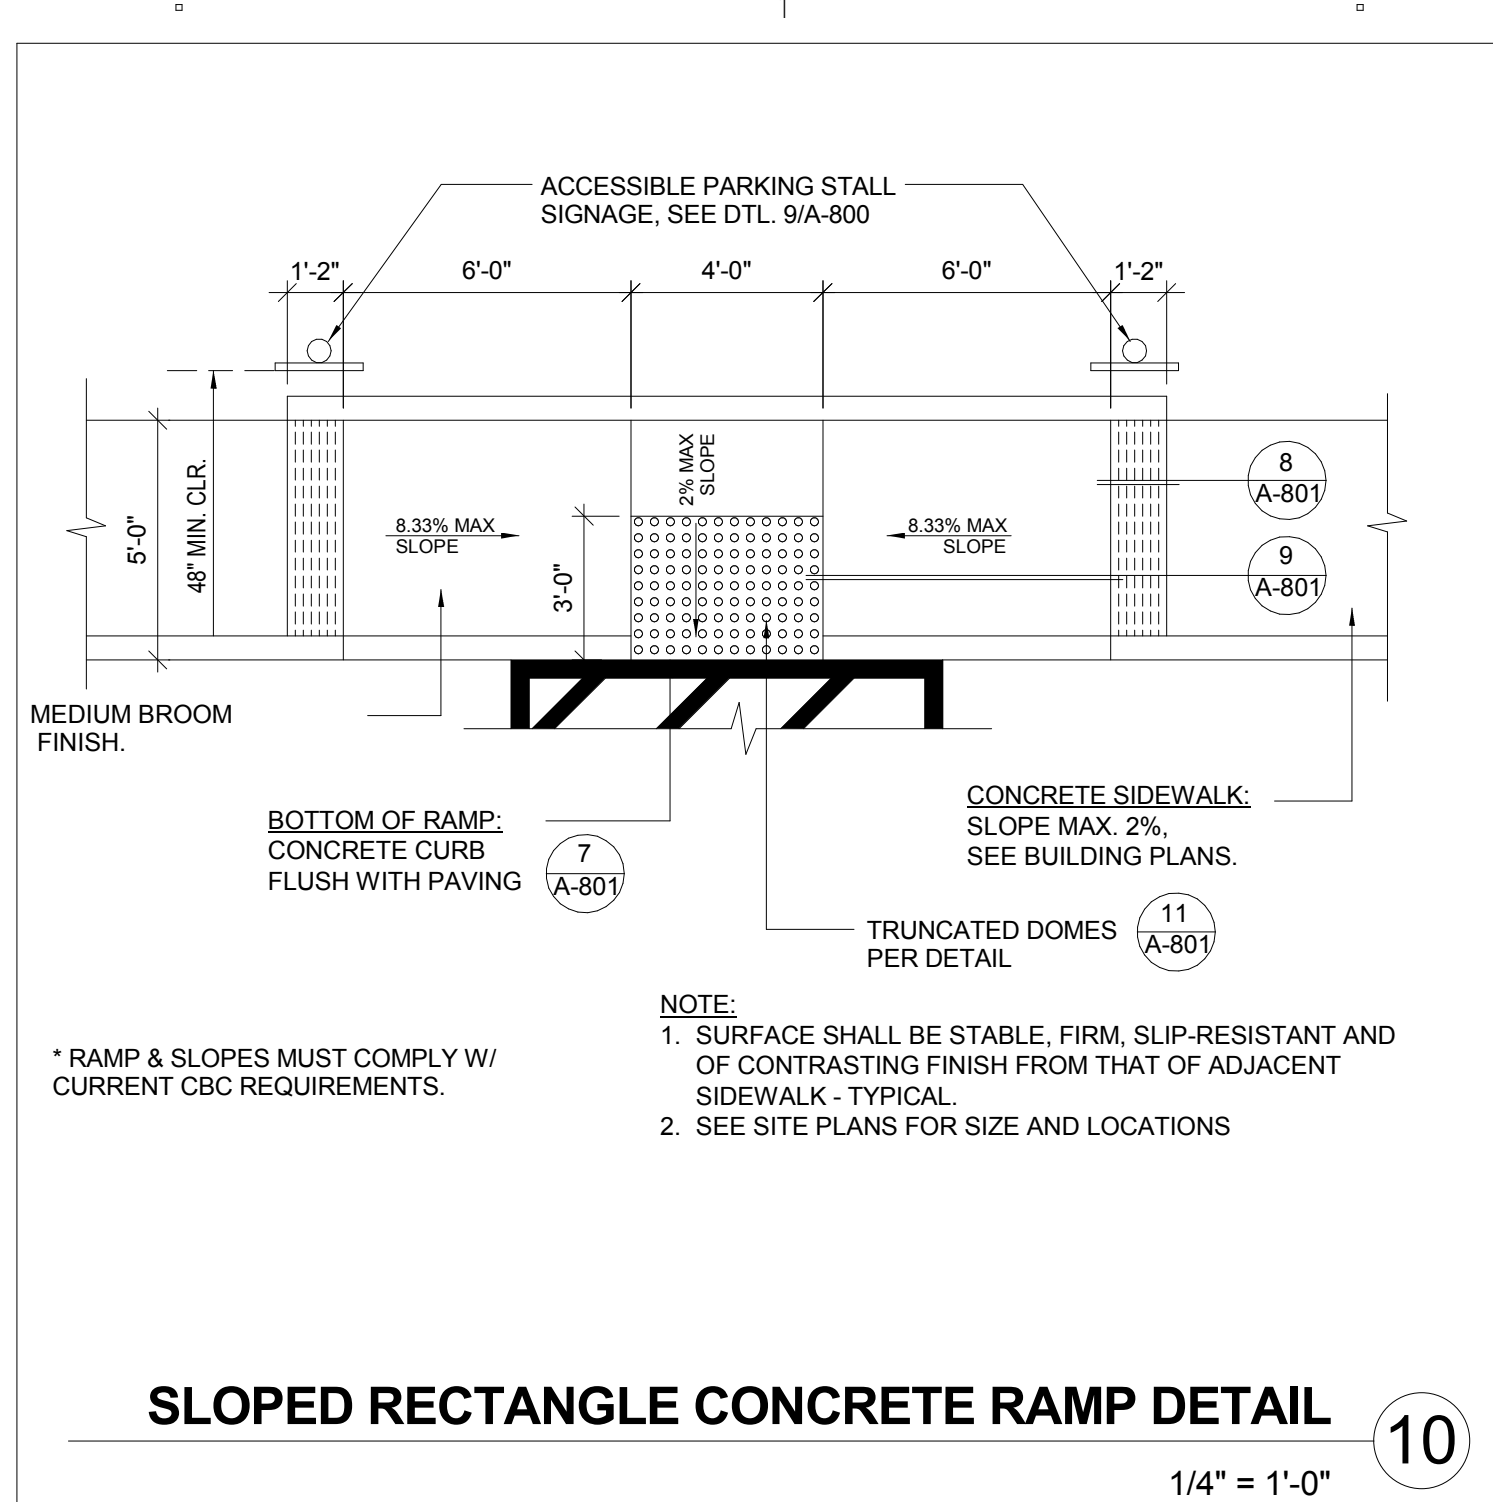

CLIENT

PALO VERDE COLLEGE
WHERE KNOWLEDGE TAKES ROOT AND OPPORTUNITY GROWS

Palo Verde Community College District
1 College Drive
Blythe, CA 92225

PROJECT NAME

Project 2
College Services Building
1 College Drive
Blythe, CA 92225

CONTRACTOR

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SILLMAN WRIGHT ARCHITECTS
31045 Temecula Parkway Suite 204
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T. 760.489.4432
www.sillmanwright.com

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REGISTRATION STAMP

ISSUE

Mark	Date	Description
Δ	3/24/2018	ADDENDUM 2

DESIGNER PROJECT NO.: 17009

DRAWN BY: Author

CHECKED BY: Checker

SCALE: As indicated

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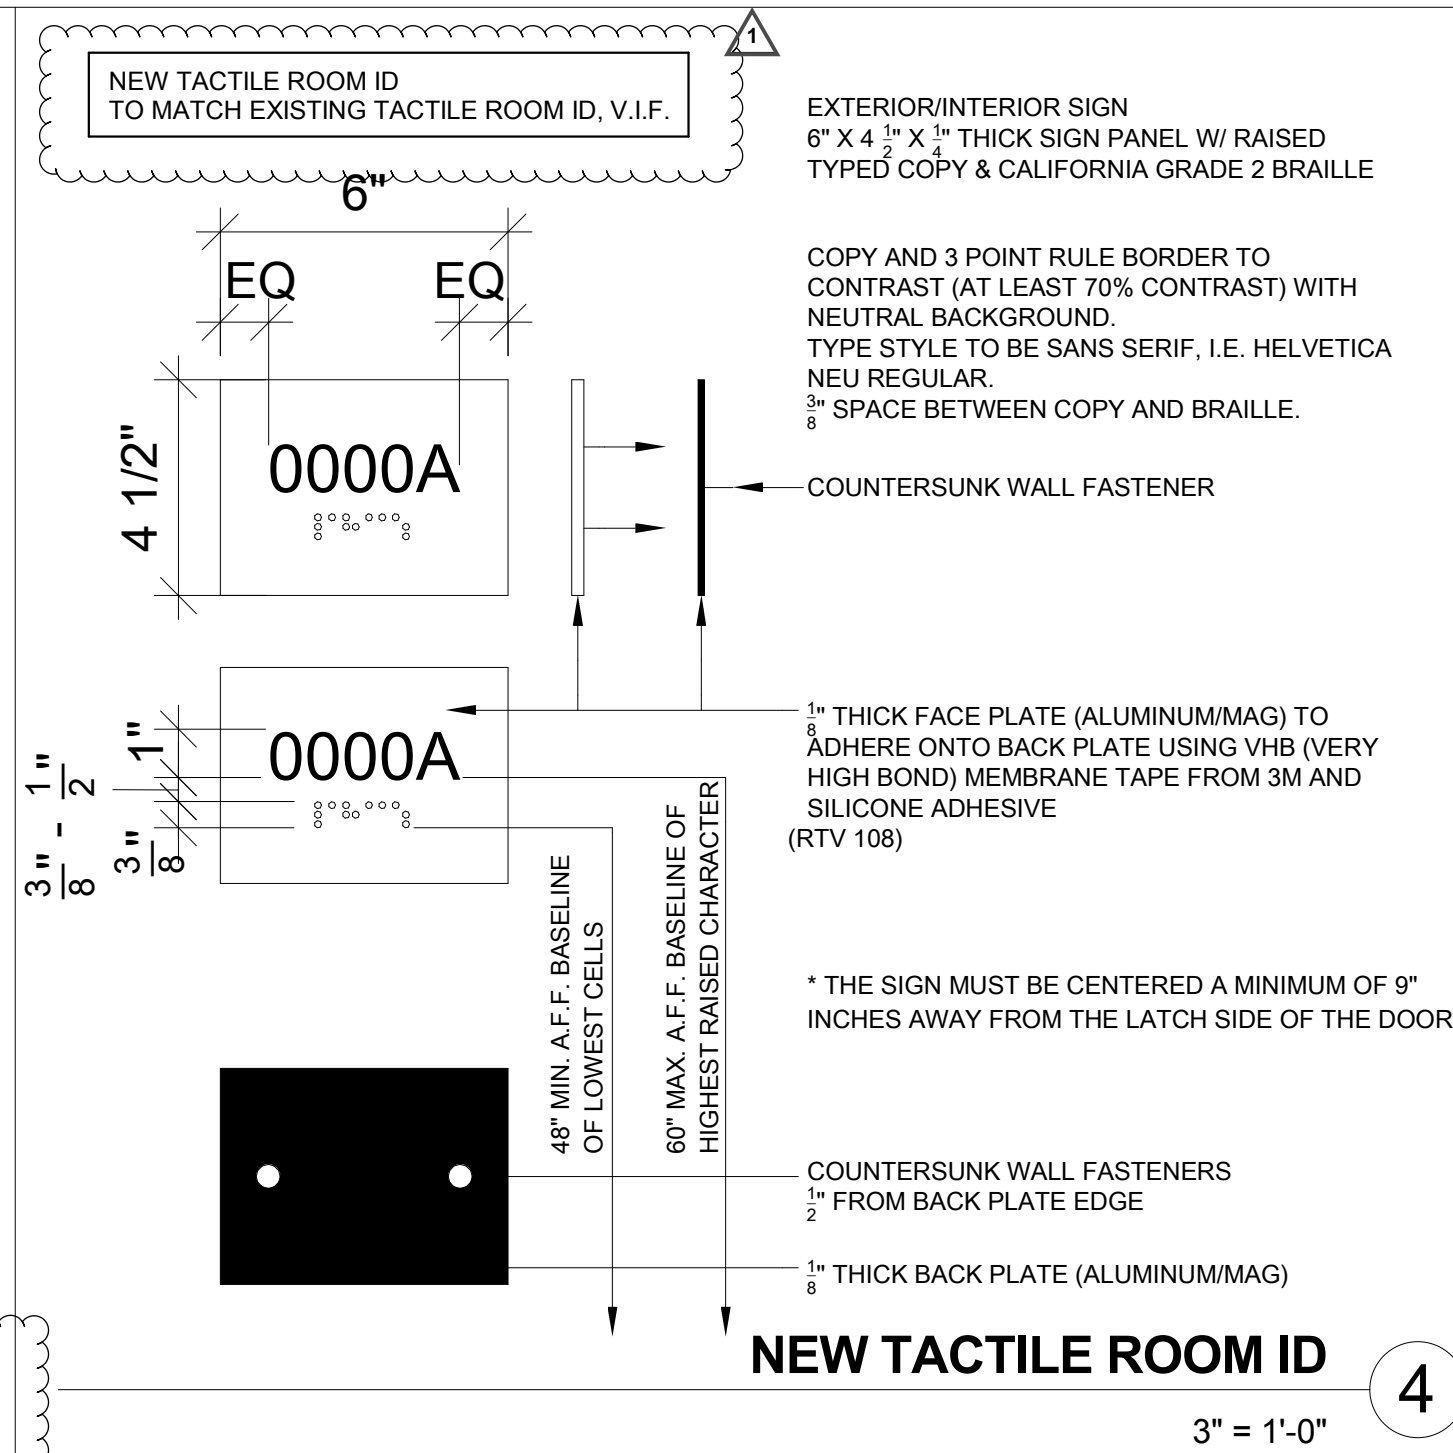
DATE 10/06/17

SHEET TITLE


DETAILS

SHEET NUMBER


A-801




NEW TACTILE ROOM ID 4
3" = 1'-0"

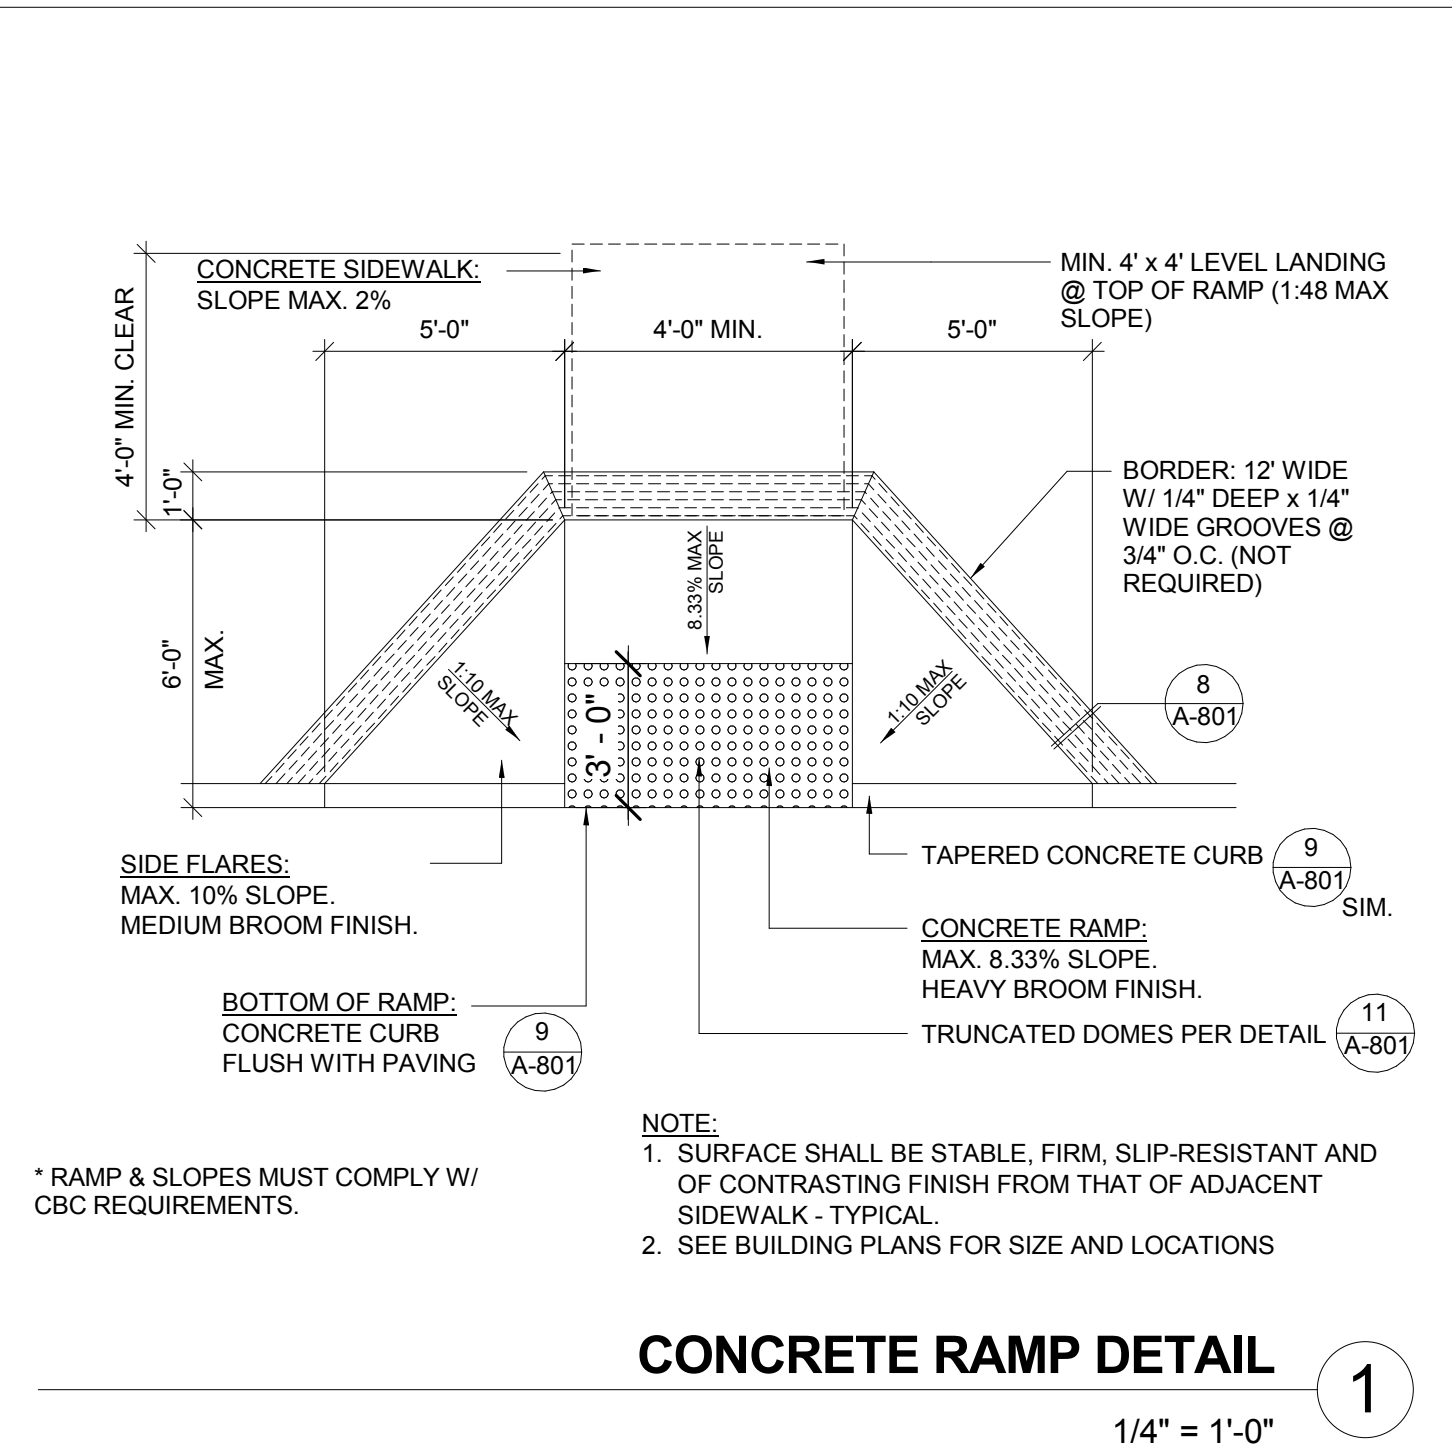


CONCRETE RAMP DETAIL 1
1/4" = 1'-0"

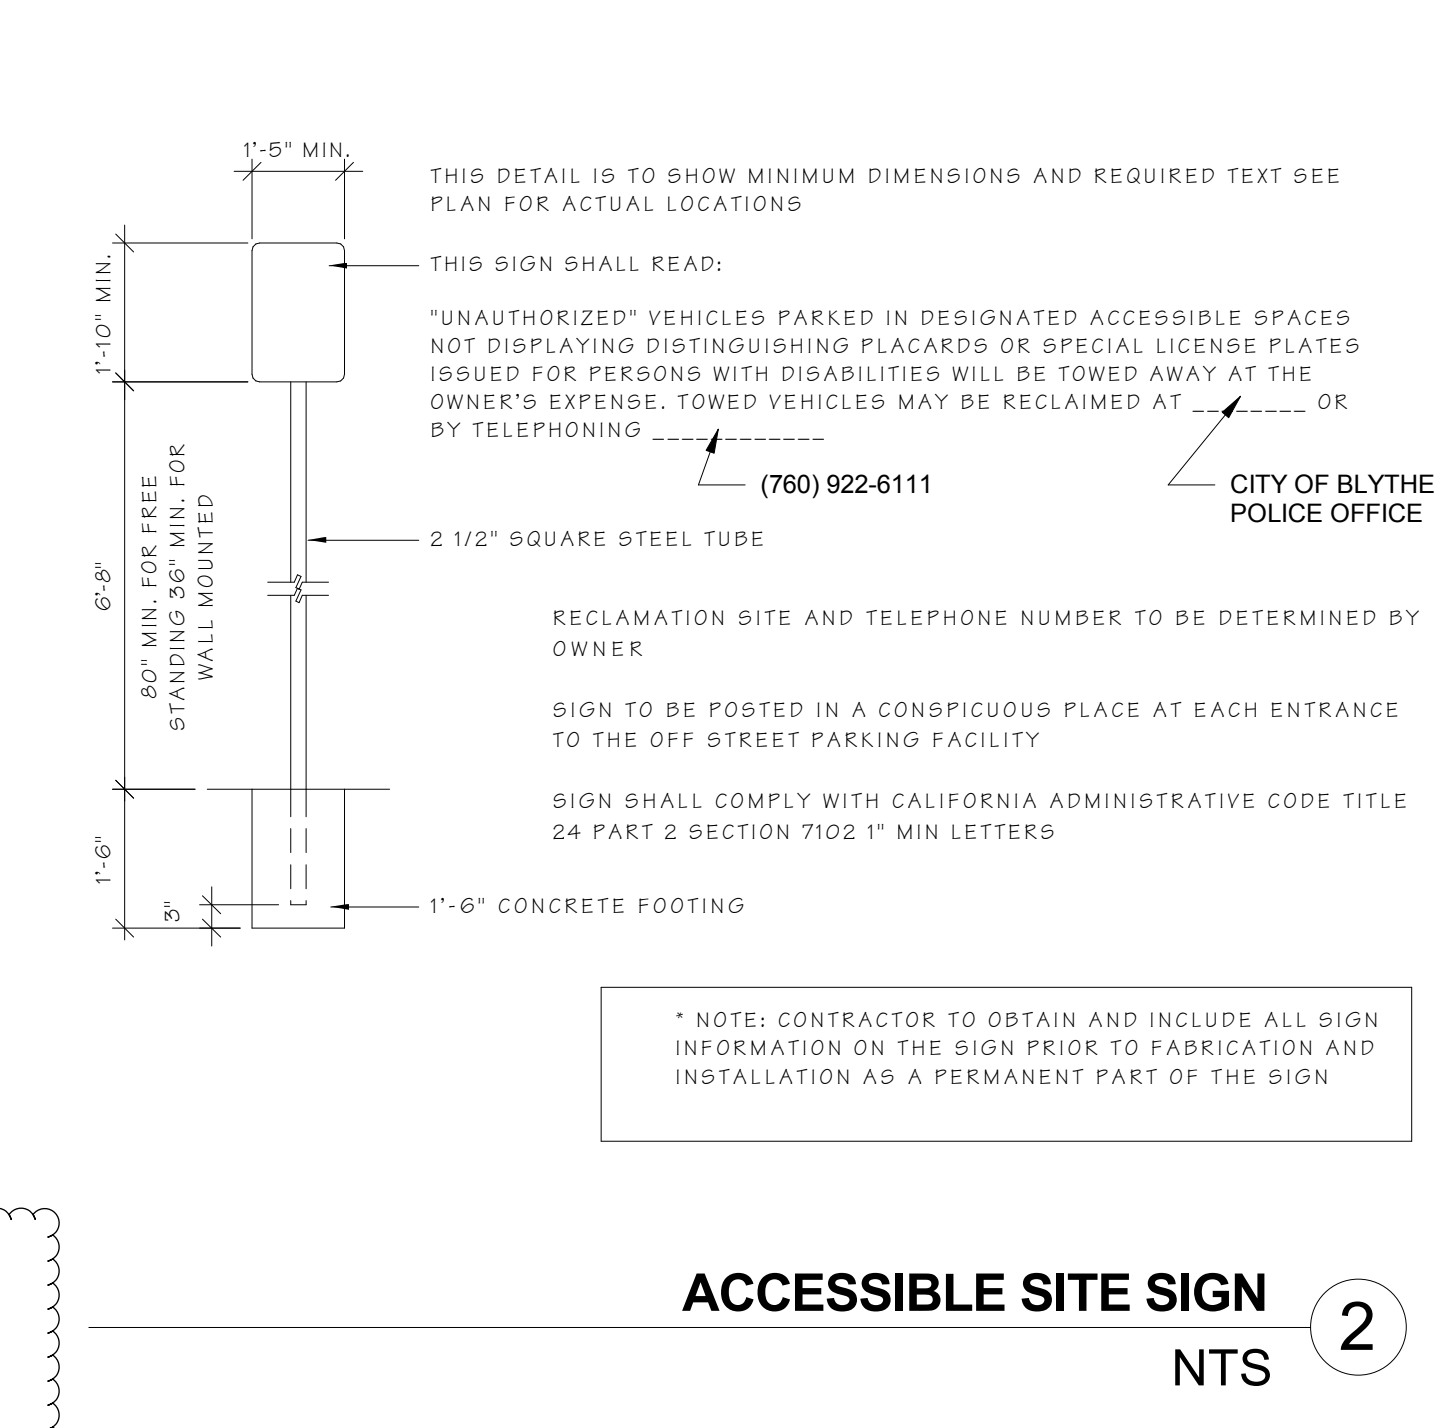

ACCESSIBLE SITE SIGN 2
NTS

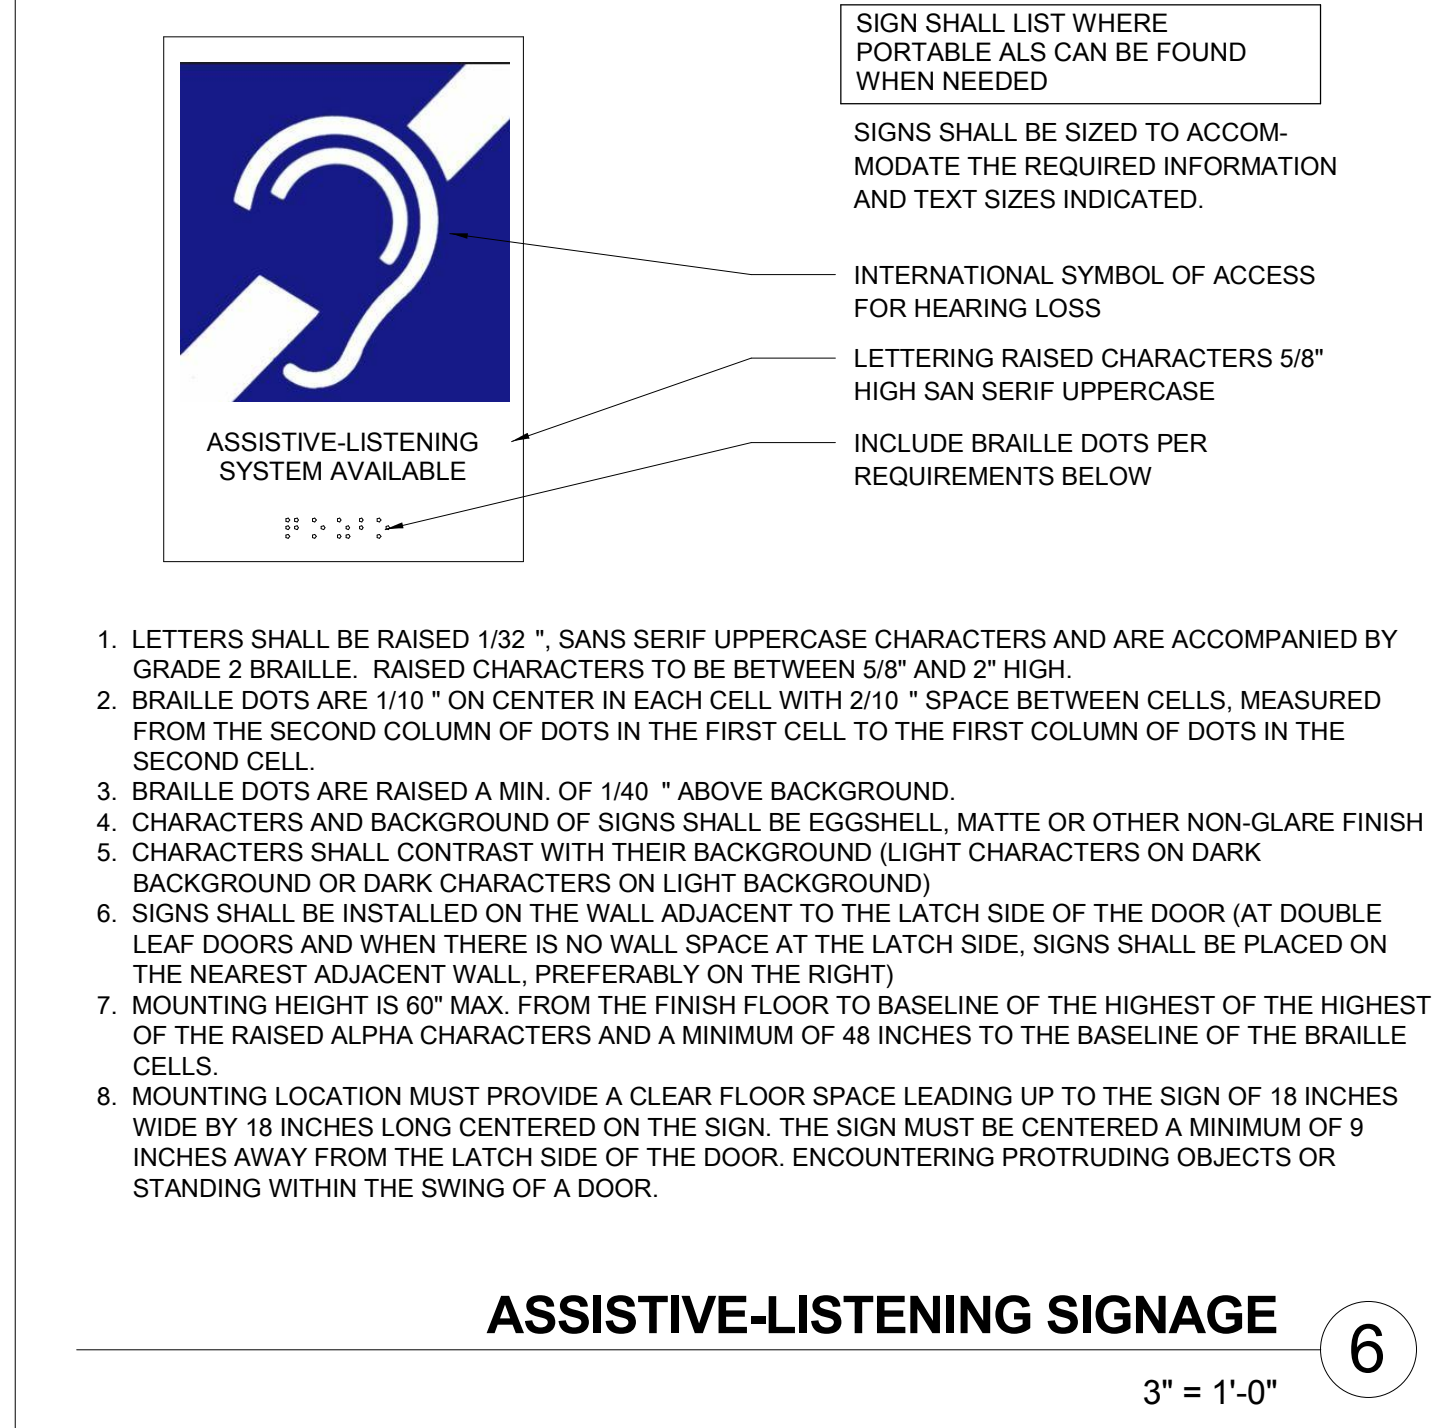

ASSISTIVE-LISTENING SIGNAGE 6
3" = 1'-0"

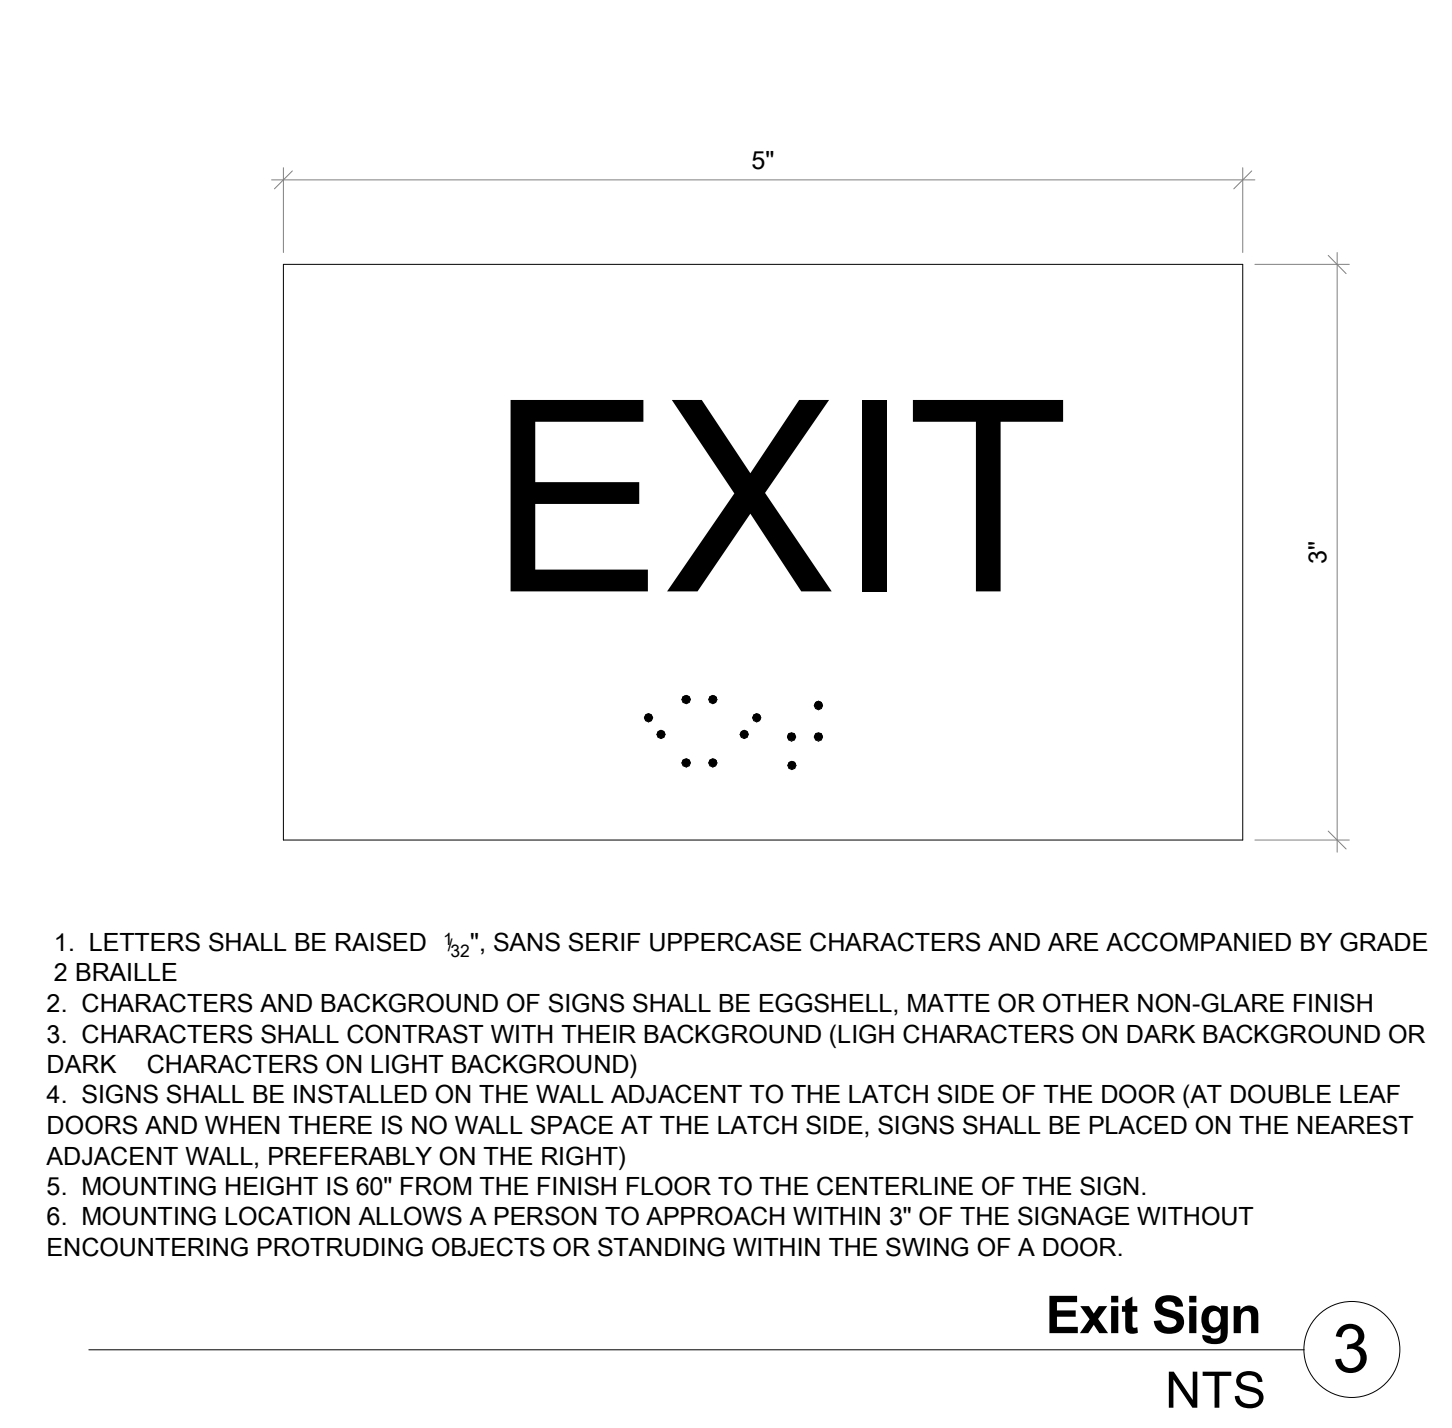

Exit Sign 3
NTS

CLIENT

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DATE 10/06/17

SHEET TITLE

DETAILS

SHEET NUMBER

A-802